	MECHANICAL A	DDD	DEVIATIONS
	WECHANICAL A	NDDN	REVIATIONS
A/C or AC	AIR CONDITIONING	KW	KILOWATT
	ABOVE FINISHED FLOOR	KWH	KILOWATT HOUR
	AIR HANDLING UNIT		
	AMERICAN SOCIETY OF HEATING, REFRIGERATION, AND AIR		LEAVING AID TEMPERATURE
	CONDITIONING ENGINEERS	LAT	LEAVING AIR TEMPERATURE
		LAV	LAVATORY
	BRITISH THERMAL UNITS	LEED	LEADERSHIP IN ENERGY AND ENVIRONMENTAL DESIGN
BTUH	BTUS PER HOUR	LWT	LEAVING WATER TEMPERATURE
	COMBUSTION AIR	MAX	MAXIMUM
	COOLING COIL	MCA	MINIMUM CIRCUIT AMPS
	AIR FLOW RATE (CUBIC FEET PER MINUTE)	MOCP	MAXIMUM OVERCURRENT PROTECTION
CHWR	CHILLED WATER RETURN	MIN	MINIMUM
	CHILLED WATER SUPPLY	NO	NOISE OBITEDIA
	CEILING	NC	NOISE CRITERIA
CW	COLD WATER	NFPA	NATIONAL FIRE PROTECTION ASSOCIATION  NOT TO SCALE
DEG or °	DEGREE	NTS	INUT TO SCALE
	DIAMETER	OSA	OUTSIDE AIR
	DRY BULB	USA	OUTSIDE AIIX
טט	DITT DOLD	PD	PRESSURE DROP
EA	EXHAUST AIR	PH or Ø	PHASE
	ENTERING AIR TEMPERATURE	PRV	PRESSURE REDUCING VALVE
	ENERGY EFFICIENCY RATIO	1100	THEOGRAPHED CONTOUT WILLYE
	EXTERNAL STATIC PRESSURE	RA	RETURN AIR
	ENTERING WATER TEMPERATURE	RPM	REVOLUTIONS PER MINUTE
		RTU	ROOFTOP UNIT
	FLOOR CLEANOUT		
	FIRE DAMPER	SA	SUPPLY AIR
	FULL LOAD AMPS	SEER	SEASONAL ENERGY EFFICIENCY RATIO
	FLOOR	SFD	COMBINATION SMOKE/FIRE DAMPER
FPM	FEET PER MINUTE	SP	STATIC PRESSURE
FT	FEET	SYM	SYMBOL
0.4	IOALIOE	T 0 D	TEMPERATURE AND RECOURE
	GAUGE	T & P TEMP	TEMPERATURE AND PRESSURE
	GRADE CLEANOUT WATER FLOW RATE (GALLONS PER MINUTE)	TYP	TEMPERATURE TYPICAL
GPIVI	WATER FLOW RATE (GALLONS FER WIINOTE)	ITP	ITPICAL
НС	HEATING COIL	UMC	UNIFORM MECHANICAL CODE
	HORSE POWER	UPC	UNIFORM PLUMBING CODE
	HEATING, VENTILATING, AIR CONDITIONING	URL	URINAL
	HOT WATER	JIL	OTHER LESS CONTRACTOR OF THE C
	HOT WATER	VTR	VENT THROUGH ROOF
	HOT WATER SUPPLY	V	VOLTS
		<u> </u>	
	INTERNATIONAL BUILDING CODE	W/	WITH
IEEC	INTERNATIONAL ENERGY CONSERVATION CODE	WB	WET-BULB
IFC	INTERNATIONAL FIRE CODE	WC	WATER CLOSET
	INTERNATIONAL FUEL GAS CODE	WCO	WALL CLEANOUT
	INTERNATIONAL MECHANICAL CODE	WH	WATER HEATER
IPC	INTERNATIONAL PLUMBING CODE		
NOTE:	THIS IS A STANDARD LIST OF COMMONLY USED MECHANICAL	ABBREVIAT	IONS. SOME OF THE ABBREVIATIONS SHOWN ABOVE MAY NOT
MUTH.	BE USED IN THIS DRAWING PACKAGE.		

#### MECHANICAL GENERAL NOTES

- 1. ALL MECHANICAL EQUIPMENT AND SYSTEMS SHALL BE INSTALLED IN ACCORDANCE WITH THE INTERNATIONAL MECHANICAL CODE (IMC) LATEST EDITION, AND ALL LOCAL & STATE CODES.
- 2. ALL PLUMBING EQUIPMENT AND SYSTEMS SHALL BE INSTALLED IN ACCORDANCE WITH THE LATEST ADOPTED PLUMBING CODE, AND ALL LOCAL & STATE CODES.
- 3. ALL MECHANICAL AND PLUMBING EQUIPMENT SHALL BE INSTALLED PER THE MANUFACTURER'S RECOMMENDATIONS.
- 4. MECHANICAL CONTRACTORS SHALL RECEIVE PRIOR APPROVAL FROM THE STRUCTURAL ENGINEER BEFORE MAKING CUTS THROUGH ANY STRUCTURAL MEMBER.
- 5. MECHANICAL CONTRACTORS SHALL COORDINATE INSTALLATION WITH CONSTRUCTION SUPERVISOR AND WITH ALL OTHER TRADES TO AVOID CONFLICTS.
- 6. THE MECHANICAL CONTRACTORS SHALL VERIFY MOTOR VOLTAGES WITH THE ELECTRICAL DRAWINGS BEFORE ORDERING MOTORIZED EQUIPMENT AND CONTROLS.
- 7. SEE MECHANICAL SCHEDULE SHEET FOR SCHEDULED CAPACITIES OF ALL MECHANICAL EQUIPMENT AND MATERIALS SPECIFIED.
- 8. DOMESTIC WATER SERVICE IS PROVIDED WITH A DOUBLE CHECK BACKFLOW PREVENTER.


METHODS OF INSTALLATION PRIOR TO THE BIDDING OF THIS PROJECT.

- 9. ALL MECHANICAL EQUIPMENT TO BE PROPOSED MUST BE ON THE APPROVED LIST PRIOR TO SUBMITTALS. ALL APPROVED MANUFACTURERS MUST BE CAPABLE OF MEETING THE REQUIREMENTS OF THE SPECIFIED EQUIPMENT.
- 10. RUNOUT AND HOOKUP SIZES TO INDIVIDUAL PLUMBING FIXTURE CAN BE FOUND ON THE PLUMBING FIXTURE SCHEDULE.
- 11. PROVIDE REMOTE CEILING ACCESS BALANCE DAMPERS WITH CONCEALED CHROME PLATE COVERS FOR BALANCE DAMPERS LOCATED ABOVE HARD CEILINGS.
- 12. PAINT ALL VTR'S, FLUES, EXHAUST CAPS, AND OTHER MECHANICAL ITEMS ON THE ROOF TO MATCH THE ROOF COLOR.
- 13. INSULATED FLEXIBLE DUCTWORK MAY BE USED FOR RUNOUTS TO GRILLES AND DIFFUSERS, IN LENGTHS OF 6'-0" OR LESS.
- 14. MAINTAIN MINIMUM OF 10'-0" DISTANCE BETWEEN ALL FRESH AIR INTAKES AND EXHAUST OR GAS FLUE DISCHARGES.
- TECHNICIAN BEFORE THE USE OF THE BUILDING POTABLE WATER SYSTEM.

THE PLUMBING CONTRACTOR IS RESPONSIBLE FOR ALL BACKFLOW DEVICES TO BE INSPECTED BY A CERTIFIED BACKFLOW

- 16. LOCATE ACCESS HATCHES SO AS TO PROVIDE OPTIMUM SERVICEABILITY TO EQUIPMENT AND/OR VALVING. SEE ARCHITECTURAL SPECIFICATION FOR TYPE AND COLOR. COORDINATE LOCATION WITH STRUCTURAL & LIGHTING.
- 17. WHENEVER THERE IS A DISCREPANCY BETWEEN THE RUNOUT DUCT SIZE SHOWN ON THE PLANS AND THAT SHOWN IN THE SCHEDULE, ALWAYS USE THE LARGER OF THE TWO DUCT SIZES.
- 18. THE CONTRACTOR SHALL BE HELD RESPONSIBLE FOR VERIFICATION OF EXISTING JOB CONDITIONS PRIOR TO BID. NO ADDITIONAL COST SHALL BE AWARDED TO THE SUCCESSFUL CONTRACTOR (OR THEIR SUBCONTRACTORS) AFTER BIDS HAVE BEEN SUBMITTED AND CONTRACTS AWARDED FOR FAILURE TO VERIFY EXISTING FIELD CONDITIONS. DISCREPANCIES BETWEEN ACTUAL FIELD CONDITIONS AND CONTRACT DOCUMENTS SHALL BE BROUGHT TO THE ENGINEERS ATTENTION FOR ALTERNATIVE
- 19. UNLESS OTHERWISE NOTED ALL EXISTING MECHANICAL EQUIPMENT, PIPING, ETC, TO BE REMOVED SHALL BE DISPOSED OF BY THE CONTRACTOR UNDER THIS CONTRACT. THE OWNER SHALL RETAIN THE RIGHT TO KEEP ANY REMOVED ITEMS.
- 20. ALL DOMESTIC COLD AND HOT WATER LINES IN THE AREA OF WORK WHICH ARE NO LONGER IN USE DUE TO THIS PROJECT SHALL BE REMOVED BACK TO THE MAINS AND CAPPED.
- 21. HOLES IN EXISTING WALL OR FLOORS SHALL BE PATCHED TO MATCH EXISTING WHERE PIPING, DUCTWORK, ETC. WERE REMOVED OR ADDED DURING THIS PROJECT.
- 22. DAMAGE TO THE EXISTING FACILITY DURING THE CONSTRUCTION SHALL BE REPAIRED OR REPLACED BY THE CONTRACTOR AT NO COST TO THE OWNER.

#### MECHANICAL AND PLUMBING DRAWINGS LEGEND

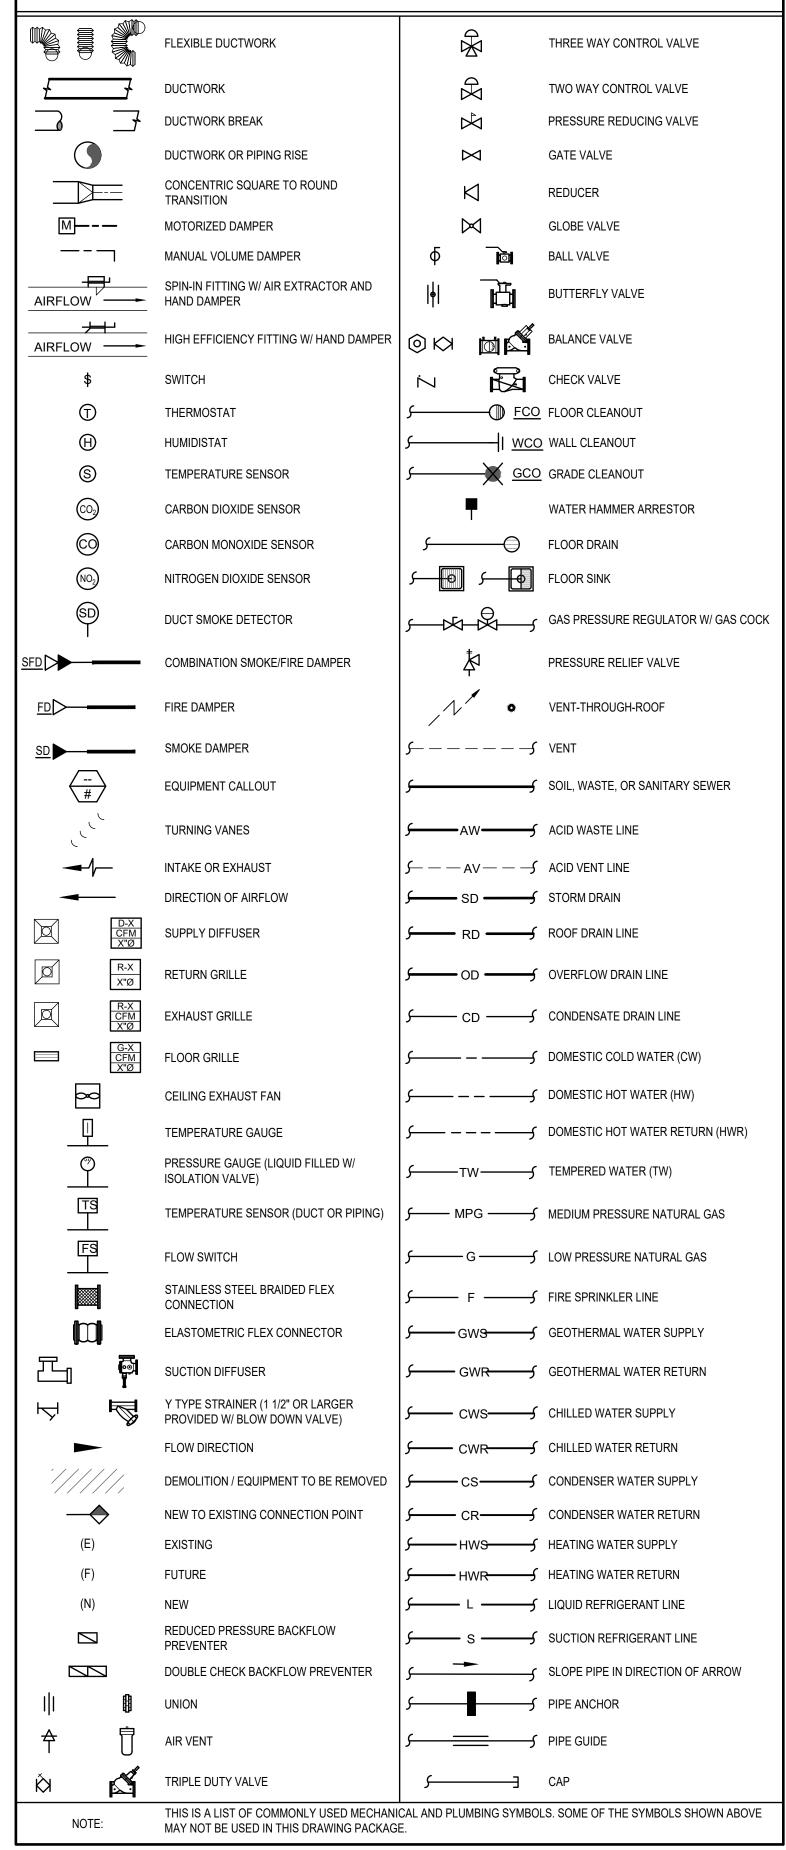

#### **ENERGY CODE COMPLIANCE**

- A. COMPLIANCE WITH THE LATEST ADOPTED EDITION OF THE INTERNATIONAL ENERGY CONSERVATION CODE IS REQUIRED FOR THIS PROJECT. THESE NOTES COVER MANDATORY REQUIREMENTS OF THE CODE. ADDITIONAL REQUIREMENTS ARE NOTED ON THE DRAWINGS AND IN THE SPECIFICATIONS.
- B. MINIMUM REQUIREMENTS FOR SUPPLY AND RETURN DUCTWORK INSULATION:
  - 1. R-6: DUCTS LOCATED IN UNCONDITIONED SPACES (SPACE NEITHER HEATED NOR COOLED SUCH AS ABOVE CEILING SPACES, WALL SPACES, DUCT CHASES, SOFFITS, ATTICS, CRAWL SPACES, UNHEATED BASEMENTS, AND UNHEATED GARAGES).
  - 2. R-12: DUCTS LOCATED OUTSIDE OF THE BUILDING'S INSULATION ENVELOPE (SUCH AS ABOVE THE ATTIC INSULATION).
  - TYPICAL INSULATION THICKNESS REQUIRED TO MEET THESE REQUIREMENTS:
  - 1. DUCT WRAP: R-6 = 1-1/2" R-12 = 4"
  - 2. DUCT LINER: R-6 = 1-1/2"

R-12 = 3"

- C. CONTRACTOR SHALL VERIFY WITH THE MANUFACTURER, THE R-VALUES OF THE ACTUAL INSULATION USED. R-VALUES SHALL BE INSTALLED VALUES.
- D. WHERE DUCTS USED FOR COOLING ARE EXTERNALLY INSULATED, THE INSULATION SHALL BE COVERED WITH A VAPOR RETARDER HAVING A MAXIMUM PERMEANCE OF 0.05 PERM OR ALUMINUM FOIL HAVING A MINIMUM THICKNESS OF 2 MILS. INSULATION HAVING A PERMEANCE OF 0.05 PERMS OR LESS SHALL NOT BE REQUIRED TO BE COVERED. ALL JOINTS AND SEAMS SHALL BE SEALED TO MAINTAIN THE CONTINUITY OF THE VAPOR RETARDER.
- E. ALL DUCT JOINTS, SEAMS, AND CONNECTIONS SHALL BE FASTENED AND SEALED WITH WELDS, GASKETS, ADHESIVES, MASTIC-PLUS-EMBEDDED-FABRIC SYSTEMS, OR TAPES. TAPES AND MASTICS SHALL BE LISTED AND LABELED PER UL181A OR UL181B. DUCT TAPE IS NOT PERMITTED AS A SEALANT ON ANY METAL DUCTS. DUCT CONNECTIONS TO FLANGES OR EQUIPMENT SHALL BE SEALED AND MECHANICALLY FASTENED.
- F. MINIMUM REQUIREMENTS (THICKNESS) FOR PIPING INSULATION SHALL BE AS FOLLOWS:

- 1. HEATING WATER
   1 1/2"
   2"
   2"

   1. CHILLED WATER
   1/2"
   1"
   1"

   2. STEAM
   2 1/2"
   2 1/2"
   3"

   3. CONDENSATE RETURN
   2 1/2"
   2 1/2"
   3"

   4. REFRIGERANT
   SEE SPECIFICATIONS
- THE ABOVE INSULATION IS BASED ON HAVING A CONDUCTIVITY NOT EXCEEDING 0.27 BTU-INCH/HOUR-FT2-°F.
- G. DOMESTIC HOT WATER PIPING SYSTEMS SHALL BE INSULATED WITH 1" INSULATION HAVING A CONDUCTIVITY NOT EXCEEDING 0.27 BTU-INCH/HOUR-FT2-°F.
- H. DOMESTIC WATER HEATERS WHICH ARE NOT PROVIDED WITH INTEGRAL HEAT TRAPS AND SERVE NONCIRCULATING SYSTEMS SHALL BE PROVIDED WITH HEAT TRAPS ON THE SUPPLY AND DISCHARGE PIPING AT THE WATER HEATER.
- I. DOMESTIC HOT WATER SYSTEMS WITH RECIRCULATION PUMPS OR ELECTRIC HEAT TRACE SHALL BE CONTROLLED WITH 7-DAY TIME
- J. AN OPERATING AND MAINTENANCE MANUAL SHALL BE PROVIDED PRIOR TO ISSUANCE OF A CERTIFICATE OF OCCUPANCY. THE O&M MANUAL SHALL CONTAIN THE FOLLOWING INFORMATION AS A MINIMUM:
- 1. EQUIPMENT CAPACITY (INPUT & OUTPUT).
- 2. EQUIPMENT OPERATING AND MAINTENANCE INSTRUCTIONS.
- 3. CONTROL SYSTEM MAINTENANCE AND CALIBRATION INFORMATION, INCLUDING WIRING DIAGRAMS, SCHEMATICS, AND CONTROL SEQUENCES.
- 4. CONTROL SYSTEM SETPOINTS SHALL BE SHOWN ON CONTROL DRAWINGS, AT CONTROL DEVICES, OR IN PROGRAMMING COMMENT ON DDC SYSTEMS.
- 5. A COMPLETE WRITTEN NARRATIVE ON HOW EACH MECHANICAL SYSTEM IS INTENDED TO OPERATE.



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OVER 40 YEARS OF EXCELLENCE

Project No. 22-104




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A. THE FIRE SPRINKLER SYSTEM SHALL BE DESIGNED AND INSTALLED BY THE FIRE SPRINKLER CONTRACTOR. THIS PLAN INDICATES GENERAL PARAMETERS THE FIRE SPRINKLER CONTRACTOR MUST DESIGN AND INSTALL AROUND. THE ENGINEER/ARCHITECT/OWNER RESERVES THE RIGHT TO REVIEW AND APPROVE TEST VALVES, ZONING VALVES, FLOW SENSORS, ETC. DURING THE SUBMITTAL PROCESS.

B. FIRE SPRINKLER CONTRACTORS SHALL BE LICENSED BY THE IDAHO STATE FIRE MARSHAL, AND SHALL HAVE IN HIS/HER EMPLOY AND WITHIN 50 MILES OF THE JOB SITE AN ENGINEERING TECHNICIAN (LEVEL III), CERTIFIED BY NICET (NATIONAL INSTITUTE FOR CERTIFICATION IN ENGINEERING TECHNOLOGIES). PROOF OF BOTH MUST BE SUBMITTED TO THE ENGINEER PRIOR TO THE START OF ANY FIRE SPRINKLING DESIGN

RESPONSIBILITY OF THE FIRE SPRINKLER CONTRACTOR. THE FIRE SPRINKLER SYSTEM SHALL BE INSTALLED BY THE FIRE SPRINKLER CONTRACTOR AS REQUIRED TO SATISFY THE REQUIREMENTS OF THE LOCAL JURISDICTION AND NFPA 13, LATEST EDITION. ARCHITECT/ENGINEER ASSUMES NO RESPONSIBILITY OR LIABILITY FOR THE DESIGN OF

- D. REFER TO FIRE SPRINKLER SPECIFICATIONS FOR ADDITIONAL REQUIREMENTS.
- 802, AUX. GYM 2 807, WRESTLING 510, WEIGHT ROOM 541, COMMONS 400, BAND ROOM
- PROVIDE BETTER COVERAGE) ALLOWED. ALL SPRINKLER HEADS MUST BE FLUSH WITH
- COORDINATE EXACT ROUTING OF SPRINKLER LINE WITH THE ARCHITECT.

Area 'A'

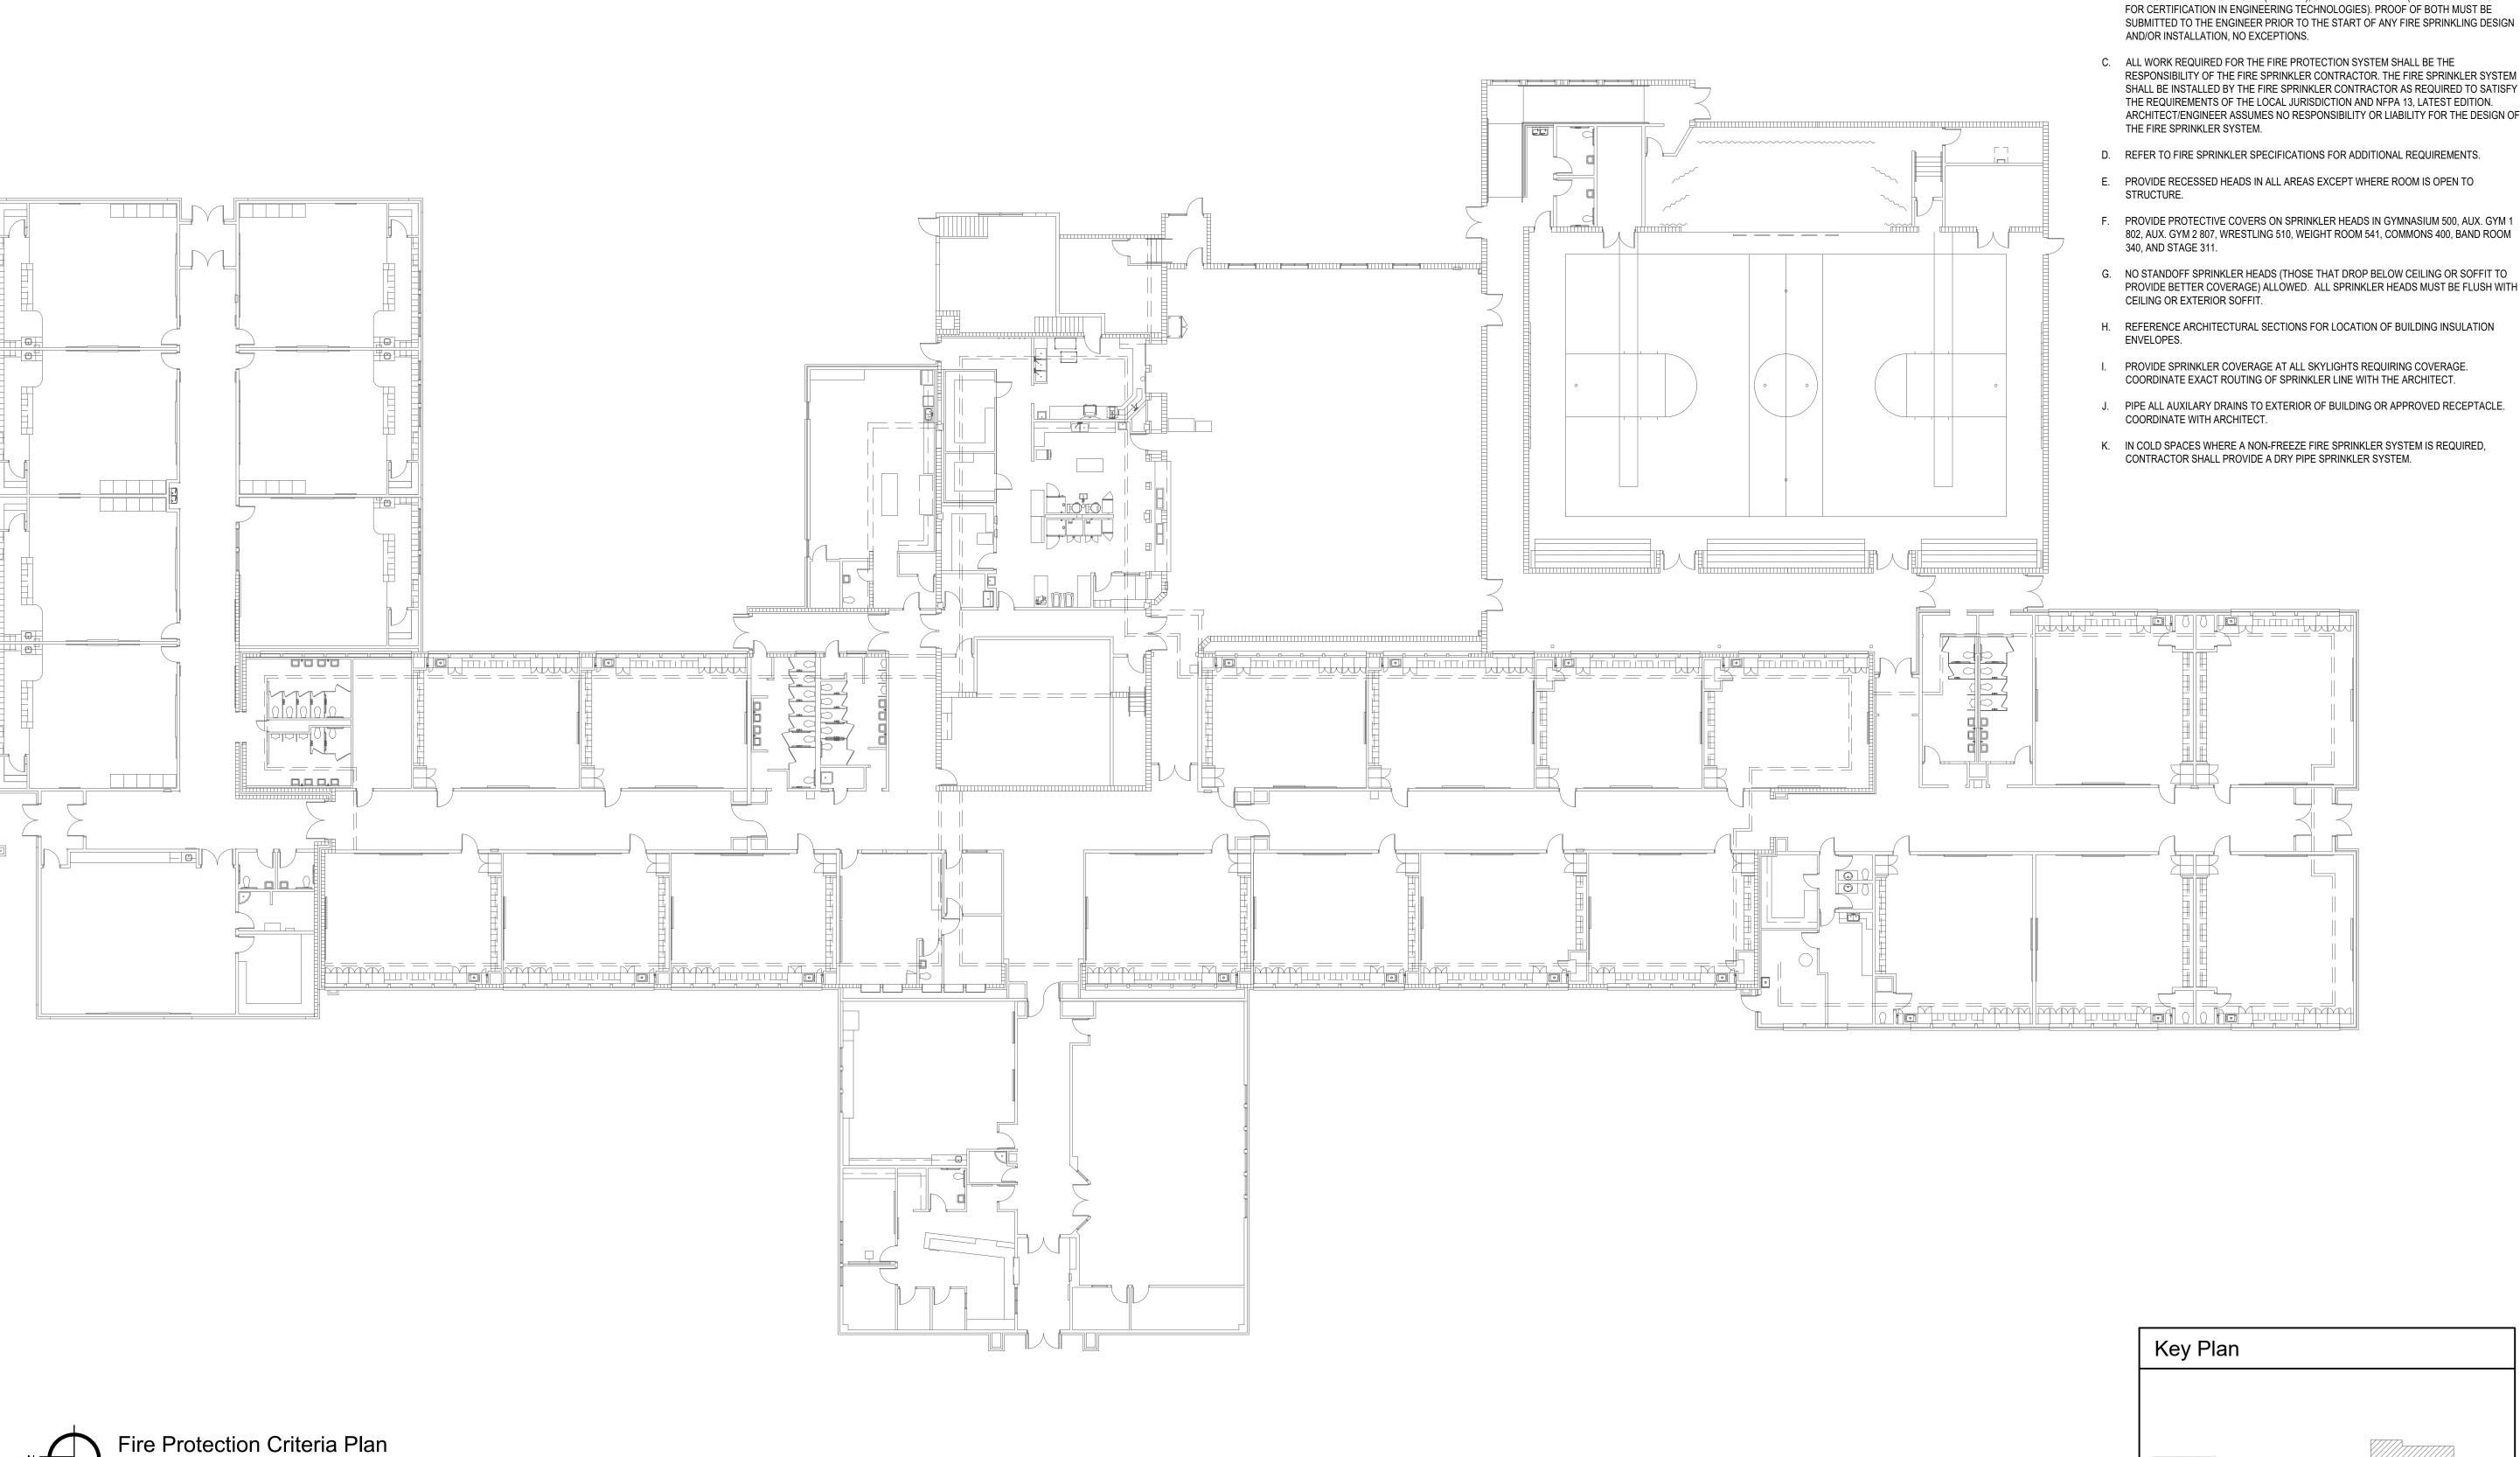Area 'D'

North Not to Scale

Area 'B'

/Area'E'/

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DRAWING NO.

M-0.2

# SYMBOL USED FOR NOTE CALLOUT.

1. KEYNOTES

Area'A'

Area 'D'

North Not to Scale

Area'B'

Area 'E'



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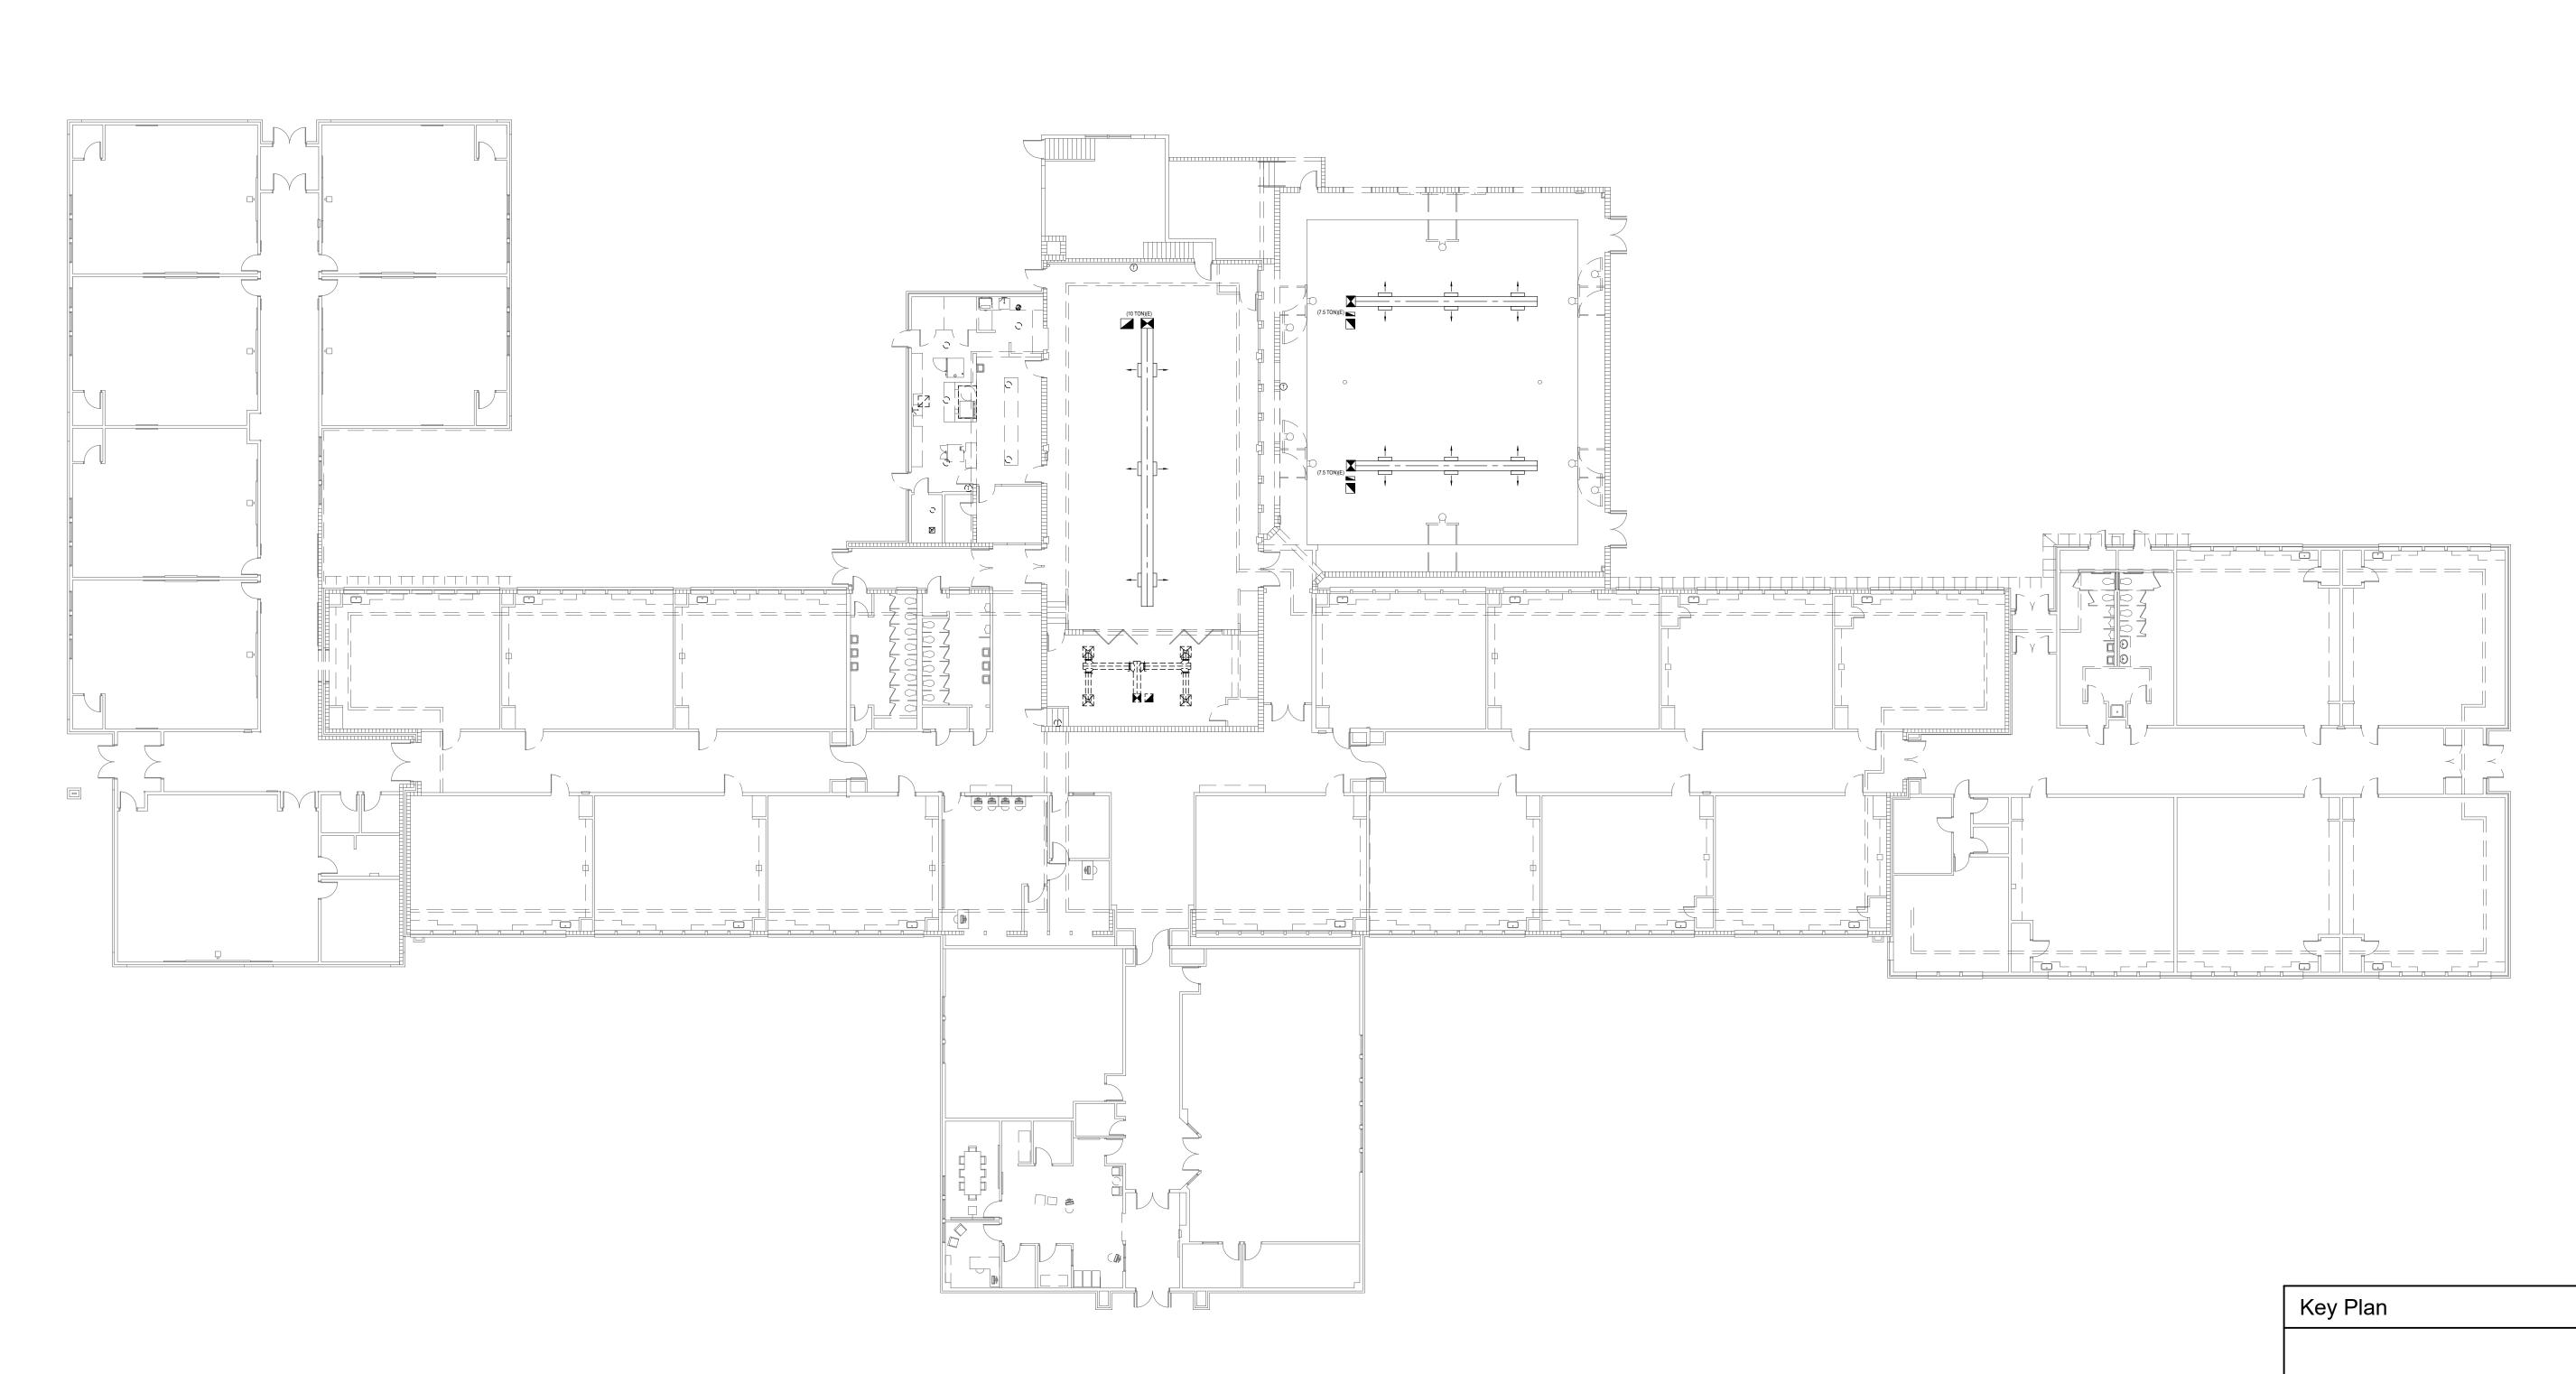
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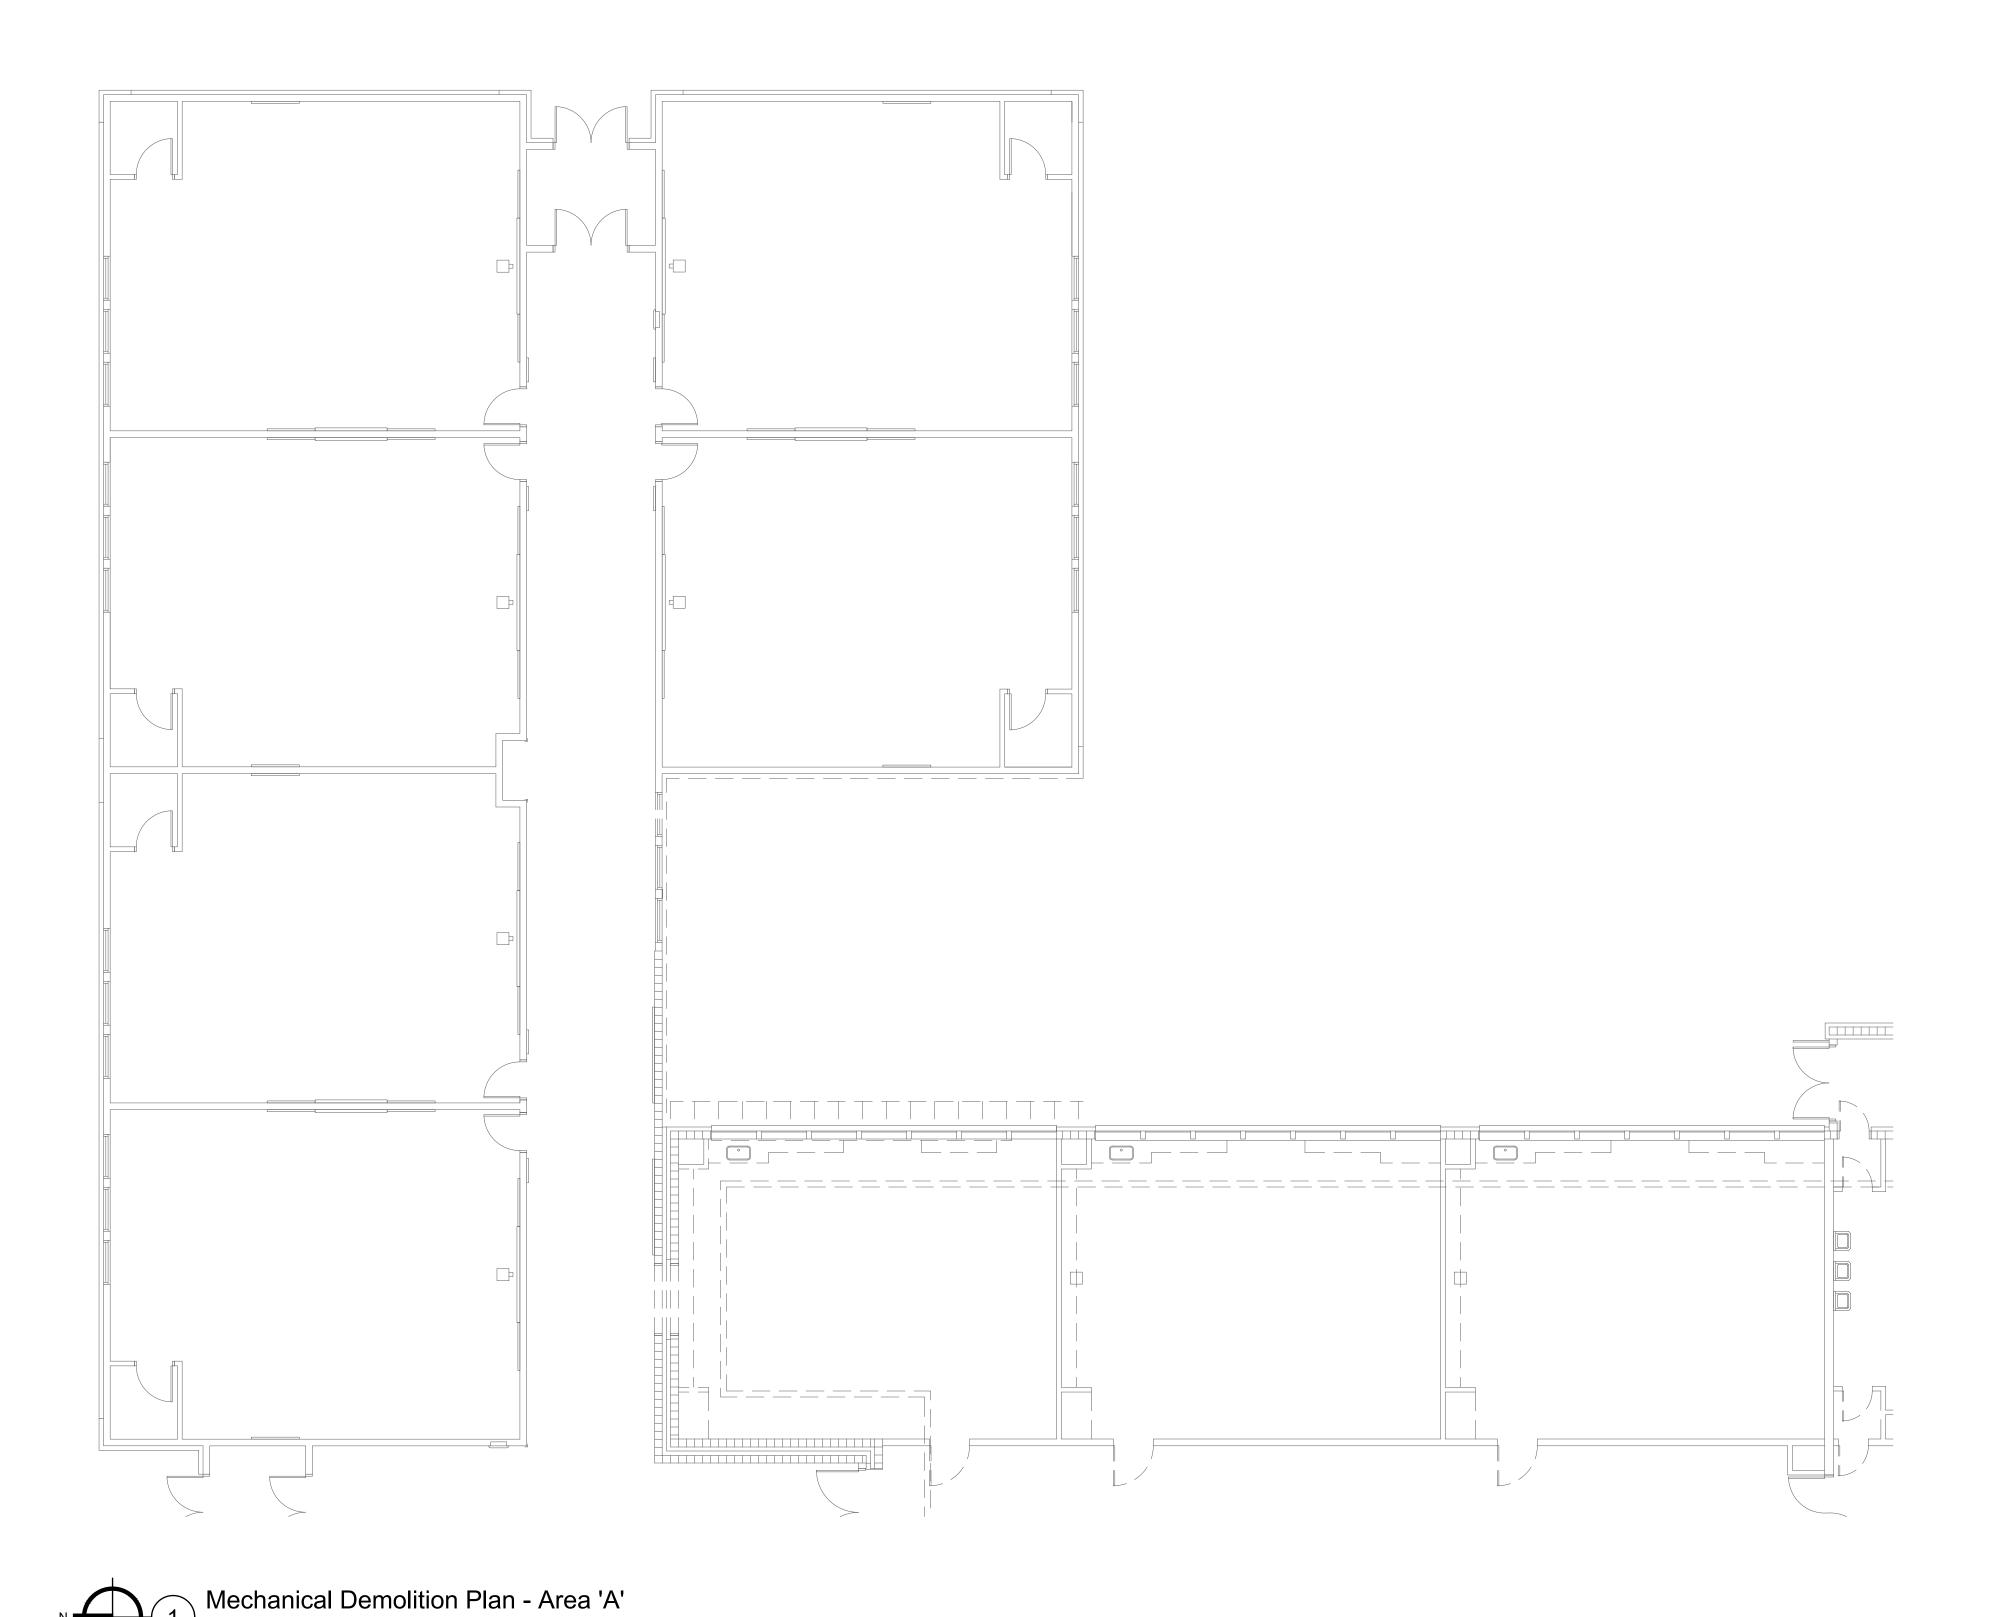
Design Development

DRAWING NO.

M-1.0







# SYMBOL USED FOR NOTE CALLOUT.

1. KEYNOTES



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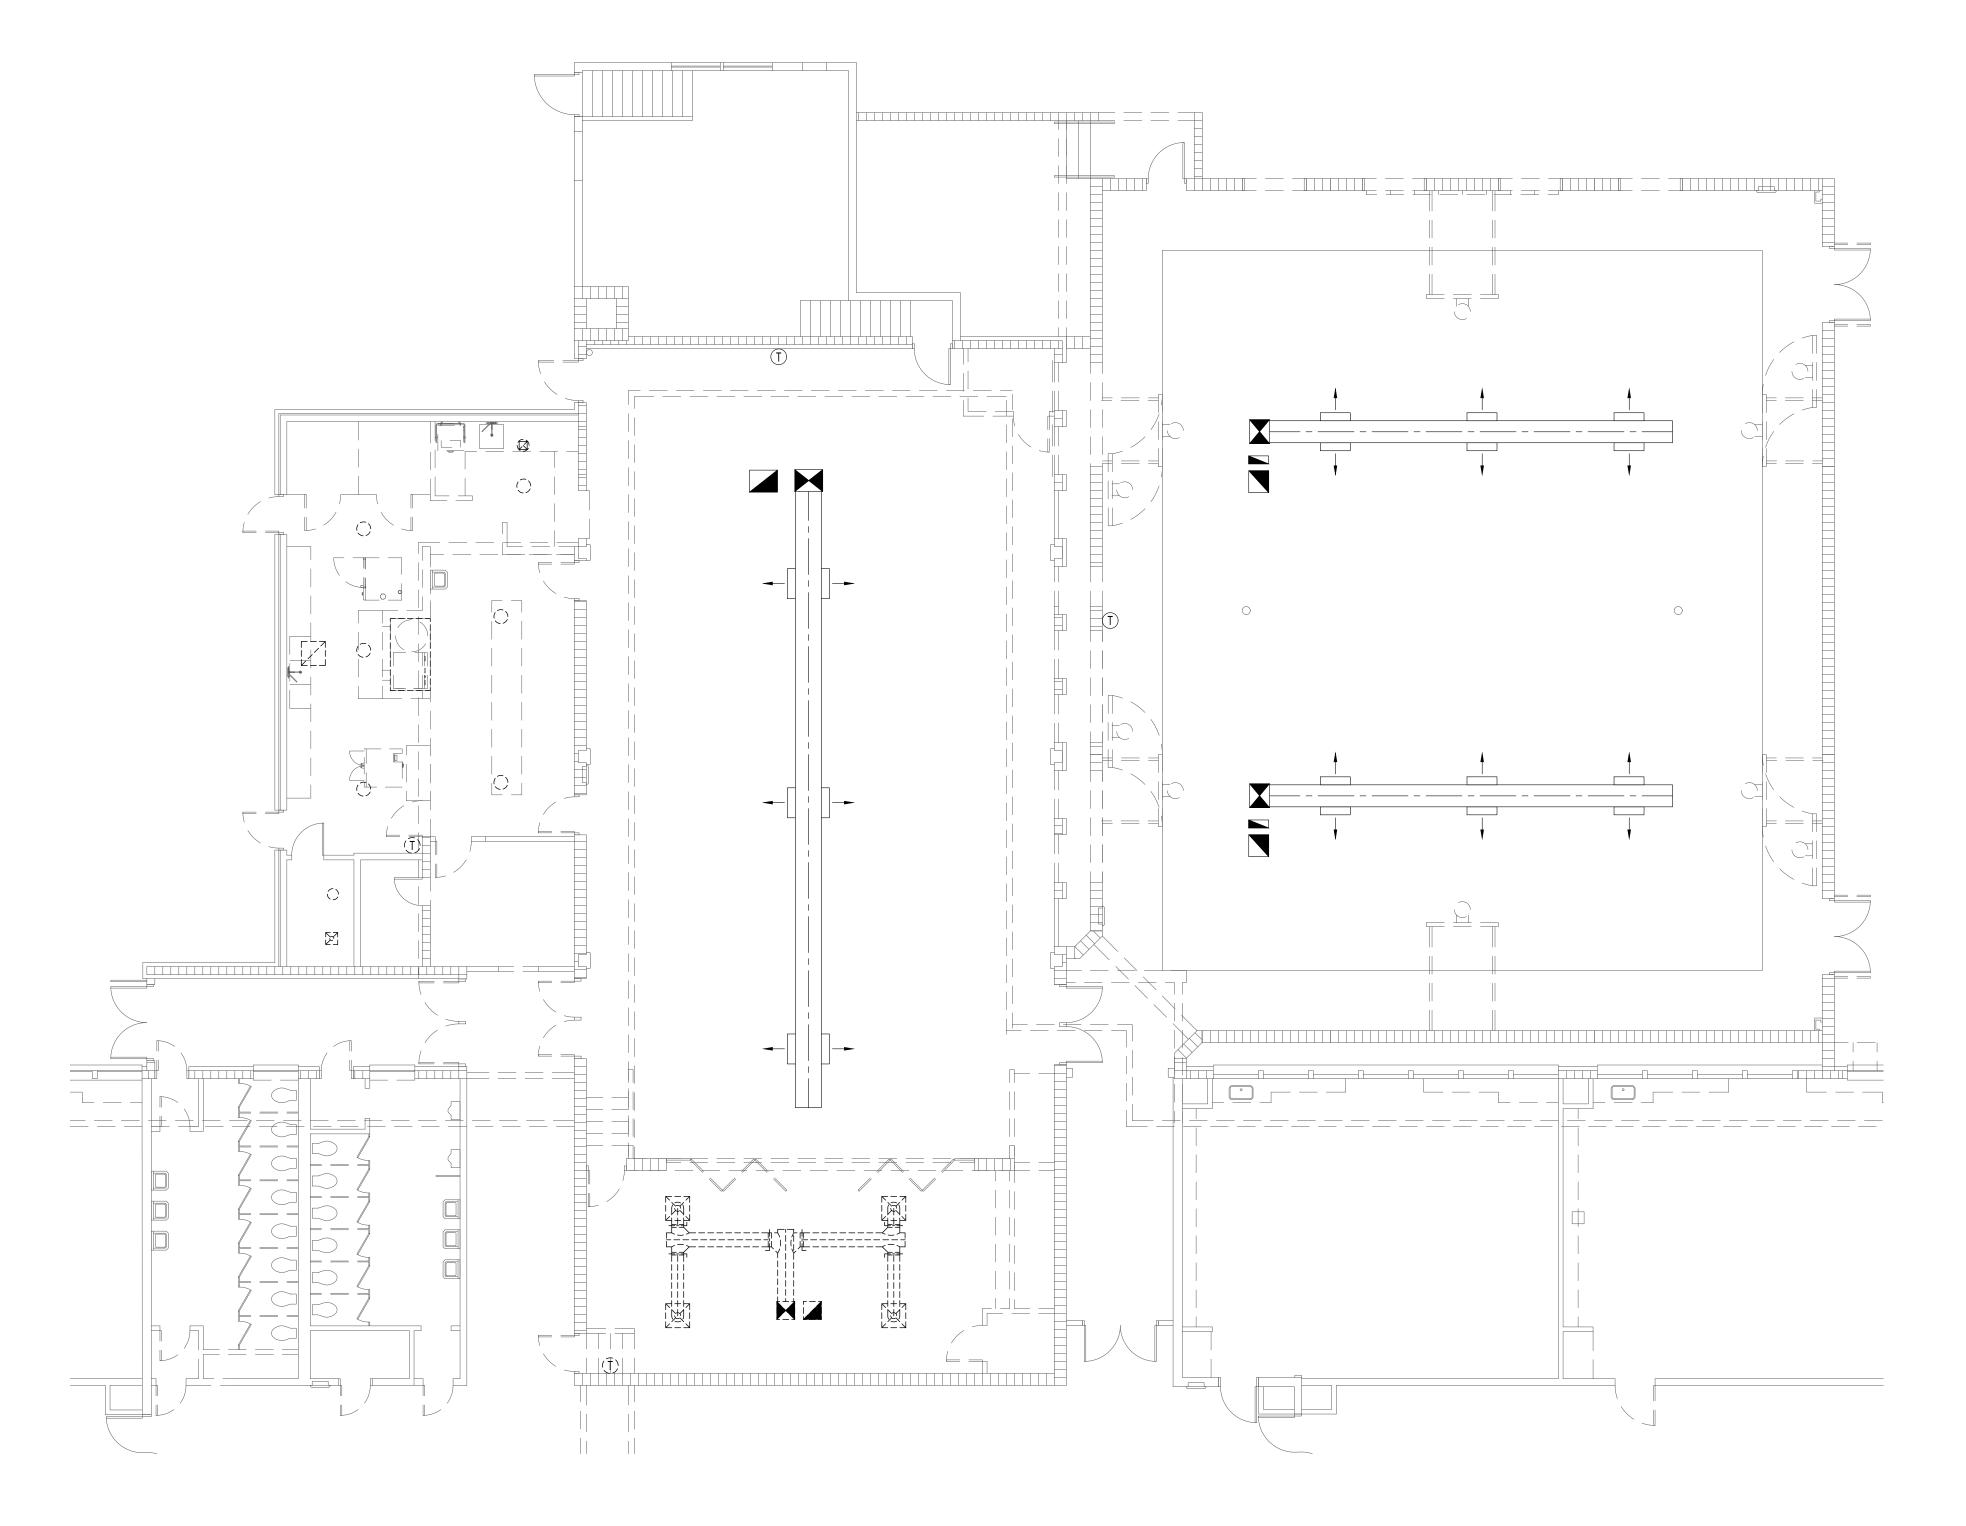
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Key Plan Area'A' Area 'B' Area 'D' Area 'E' Area 'F'



N. Mechanical Demolition Plan - Area 'B'
Scale: 1/8" = 1'-0"

# SYMBOL USED FOR NOTE CALLOUT.

1. KEYNOTES



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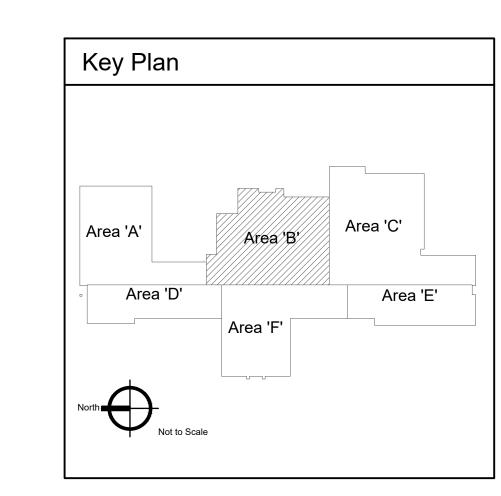


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M-1.2

Mechanical Demolition Plan - Area 'C'

#### KEYED NOTES:

# SYMBOL USED FOR NOTE CALLOUT.

1. KEYNOTES



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DRAWING NO.

Area 'A'


Area 'B'


Area 'C'


Area 'E'

Area 'F'

Key Plan

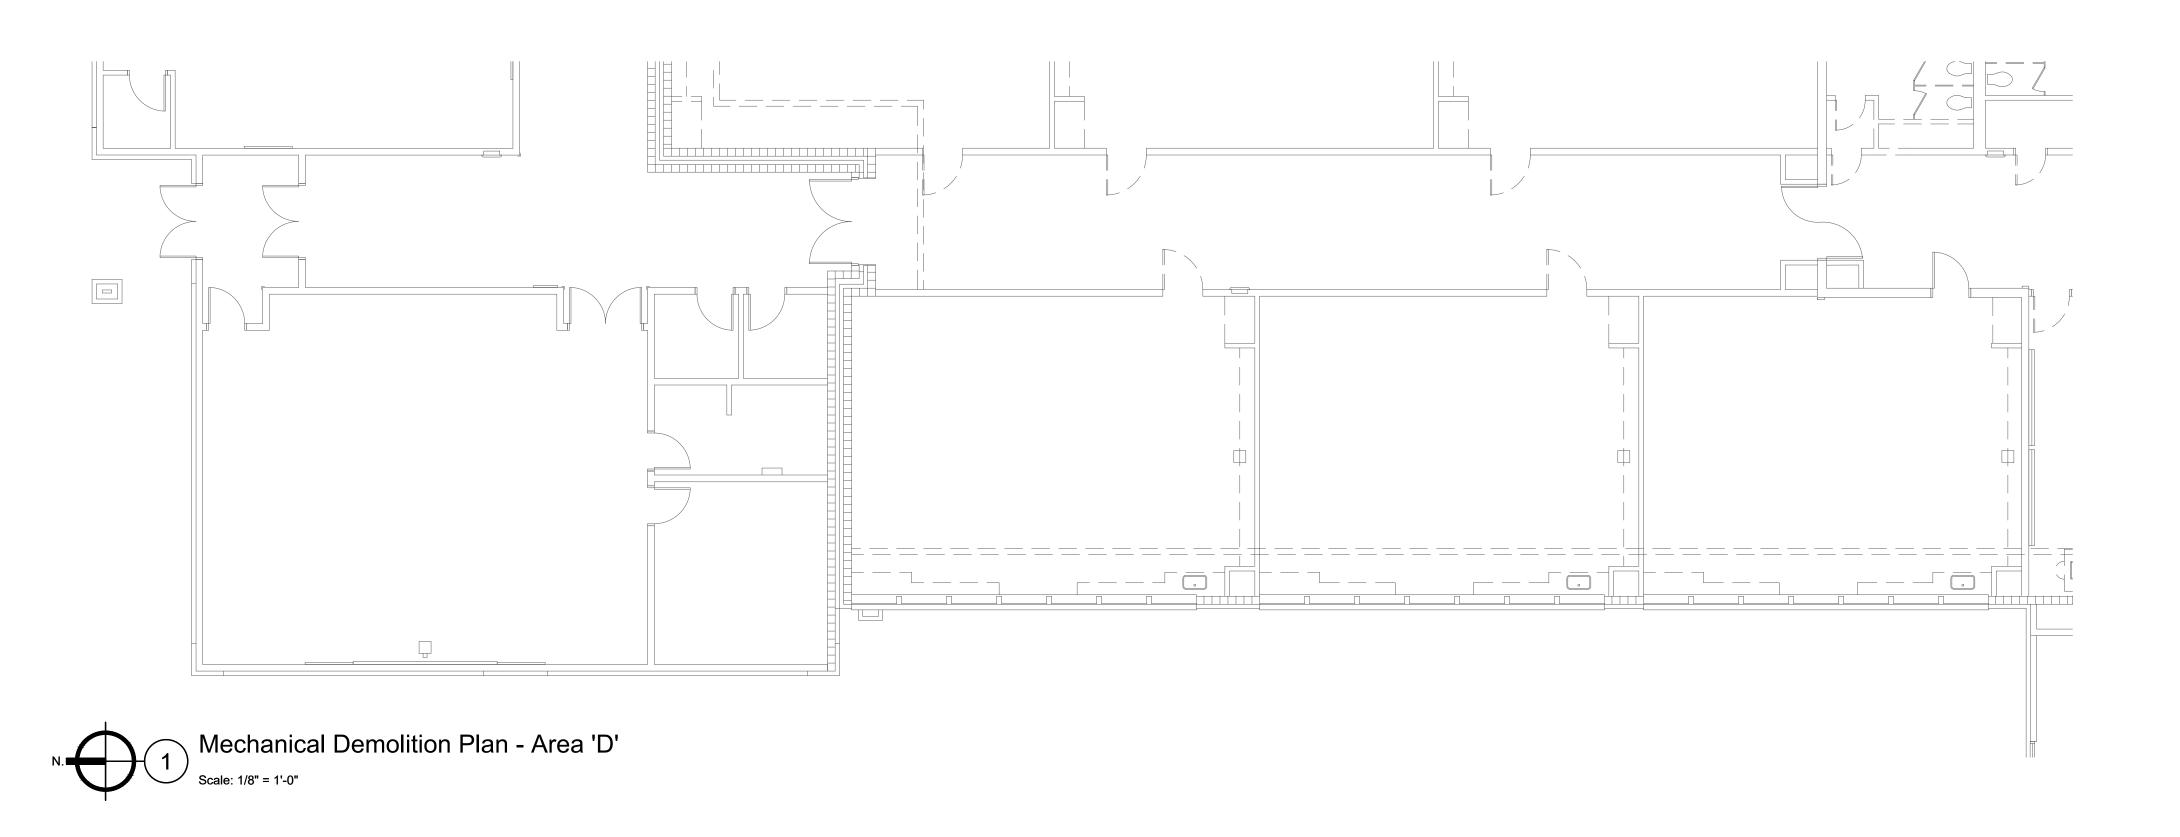

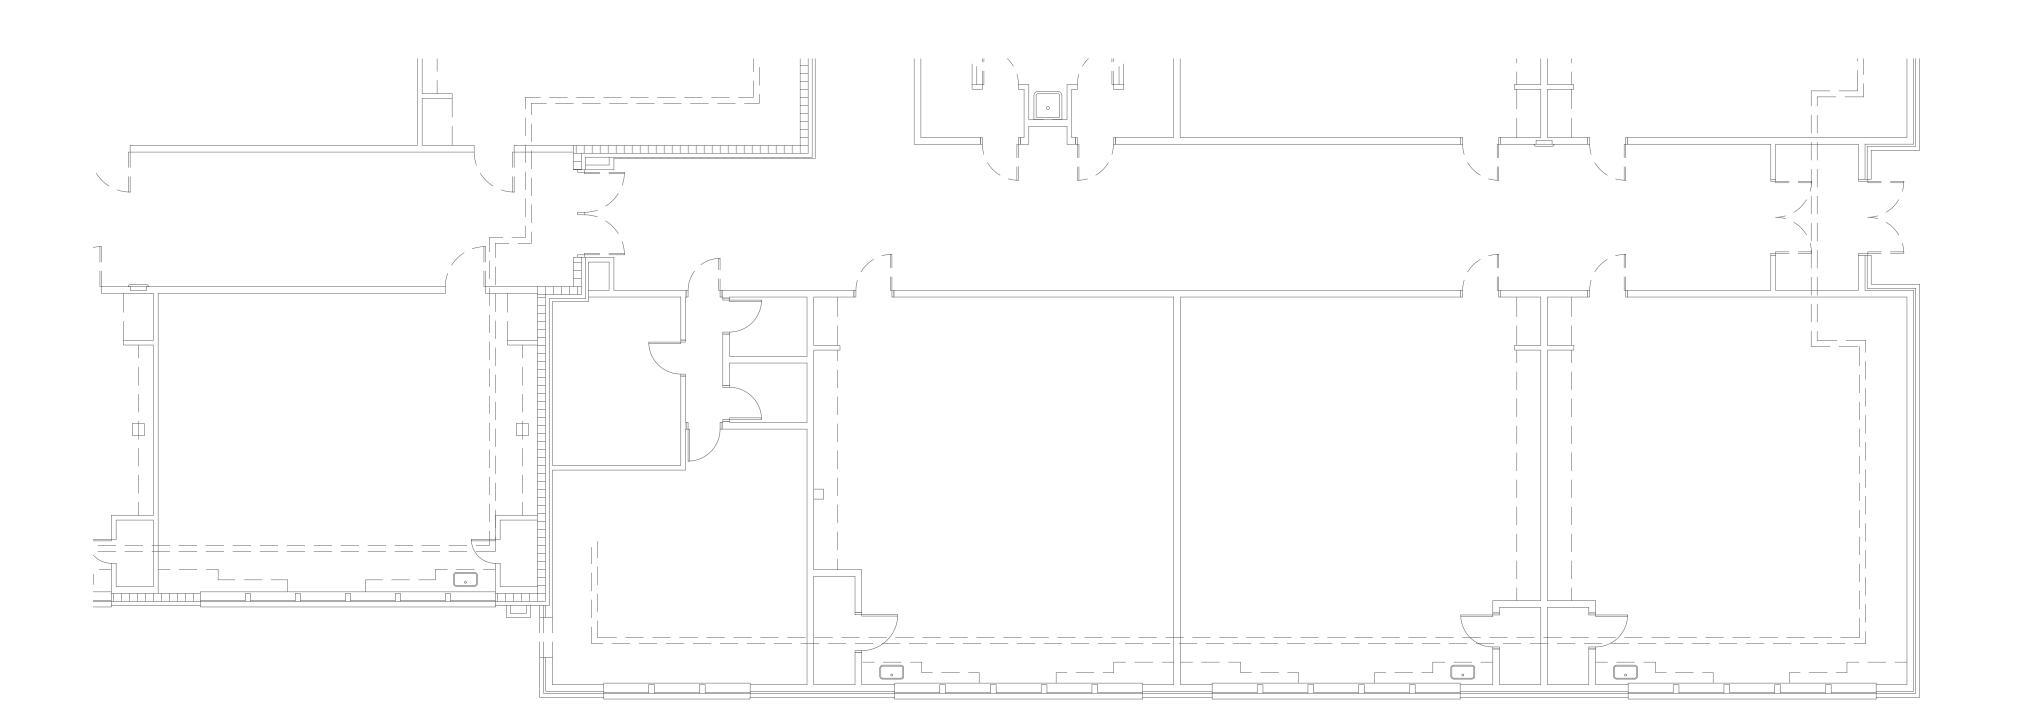

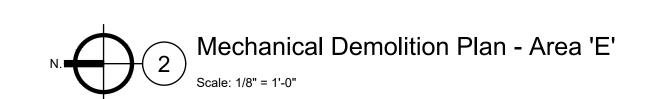

# SYMBOL USED FOR NOTE CALLOUT.

1. KEYNOTES



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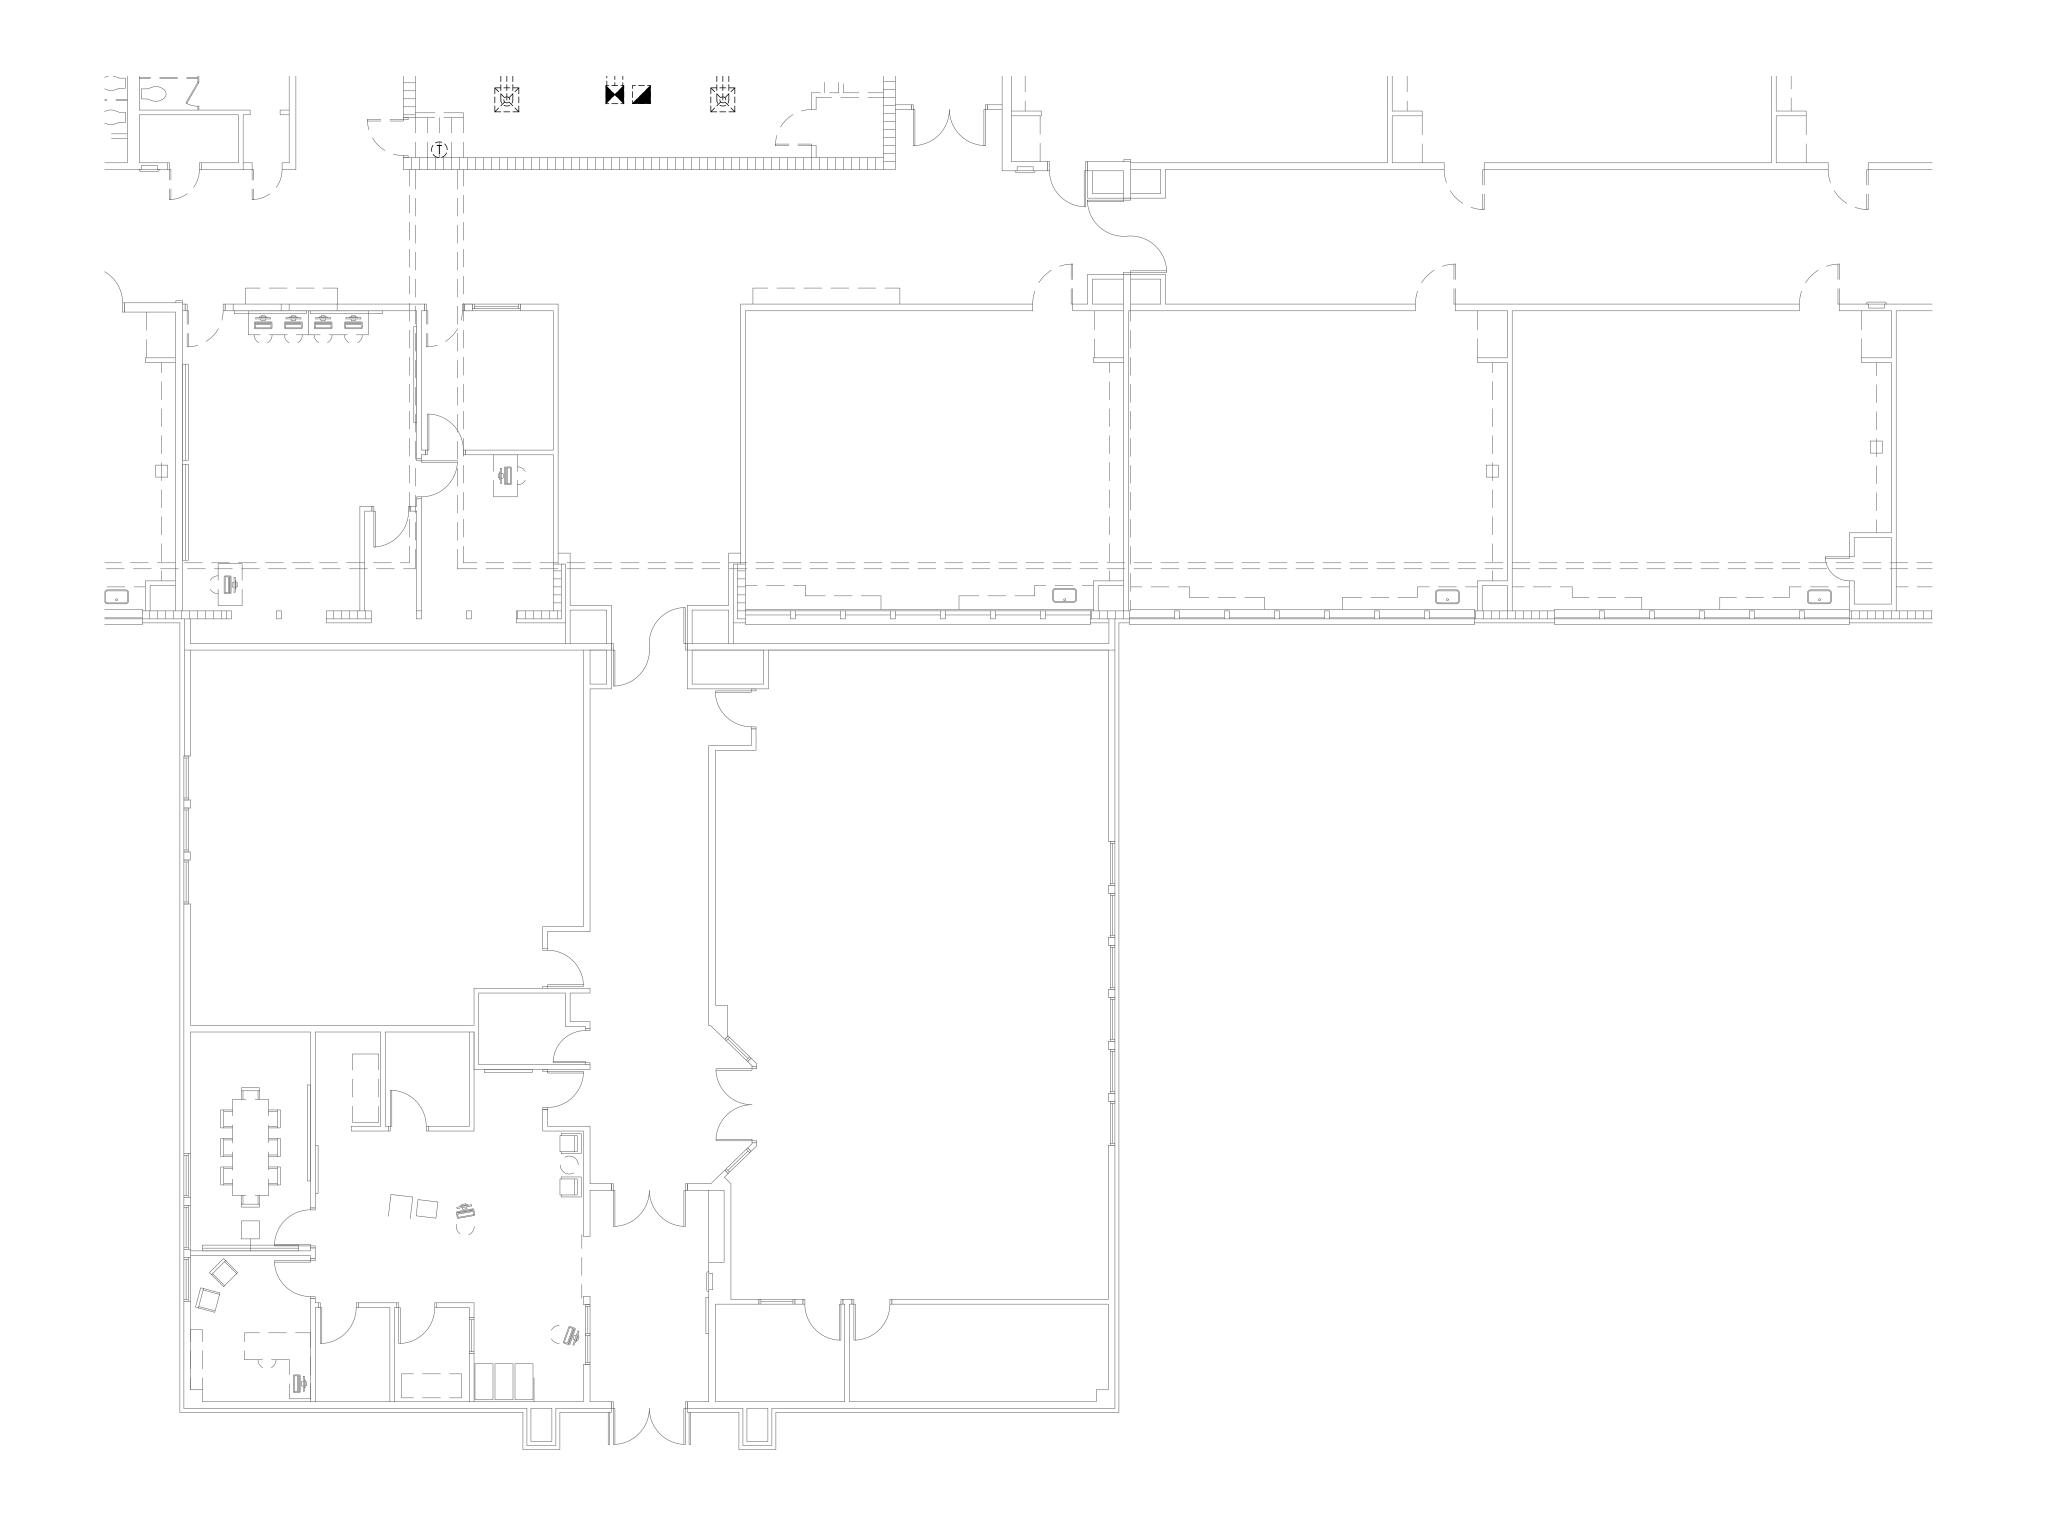
M-1.4

Area 'A'

Area 'B'

Area 'E'

North
Not to Scale





# SYMBOL USED FOR NOTE CALLOUT.

1. KEYNOTES

Key Plan

Area 'A'

Area 'D'

North Not to Scale

Area 'B'

Area 'E'



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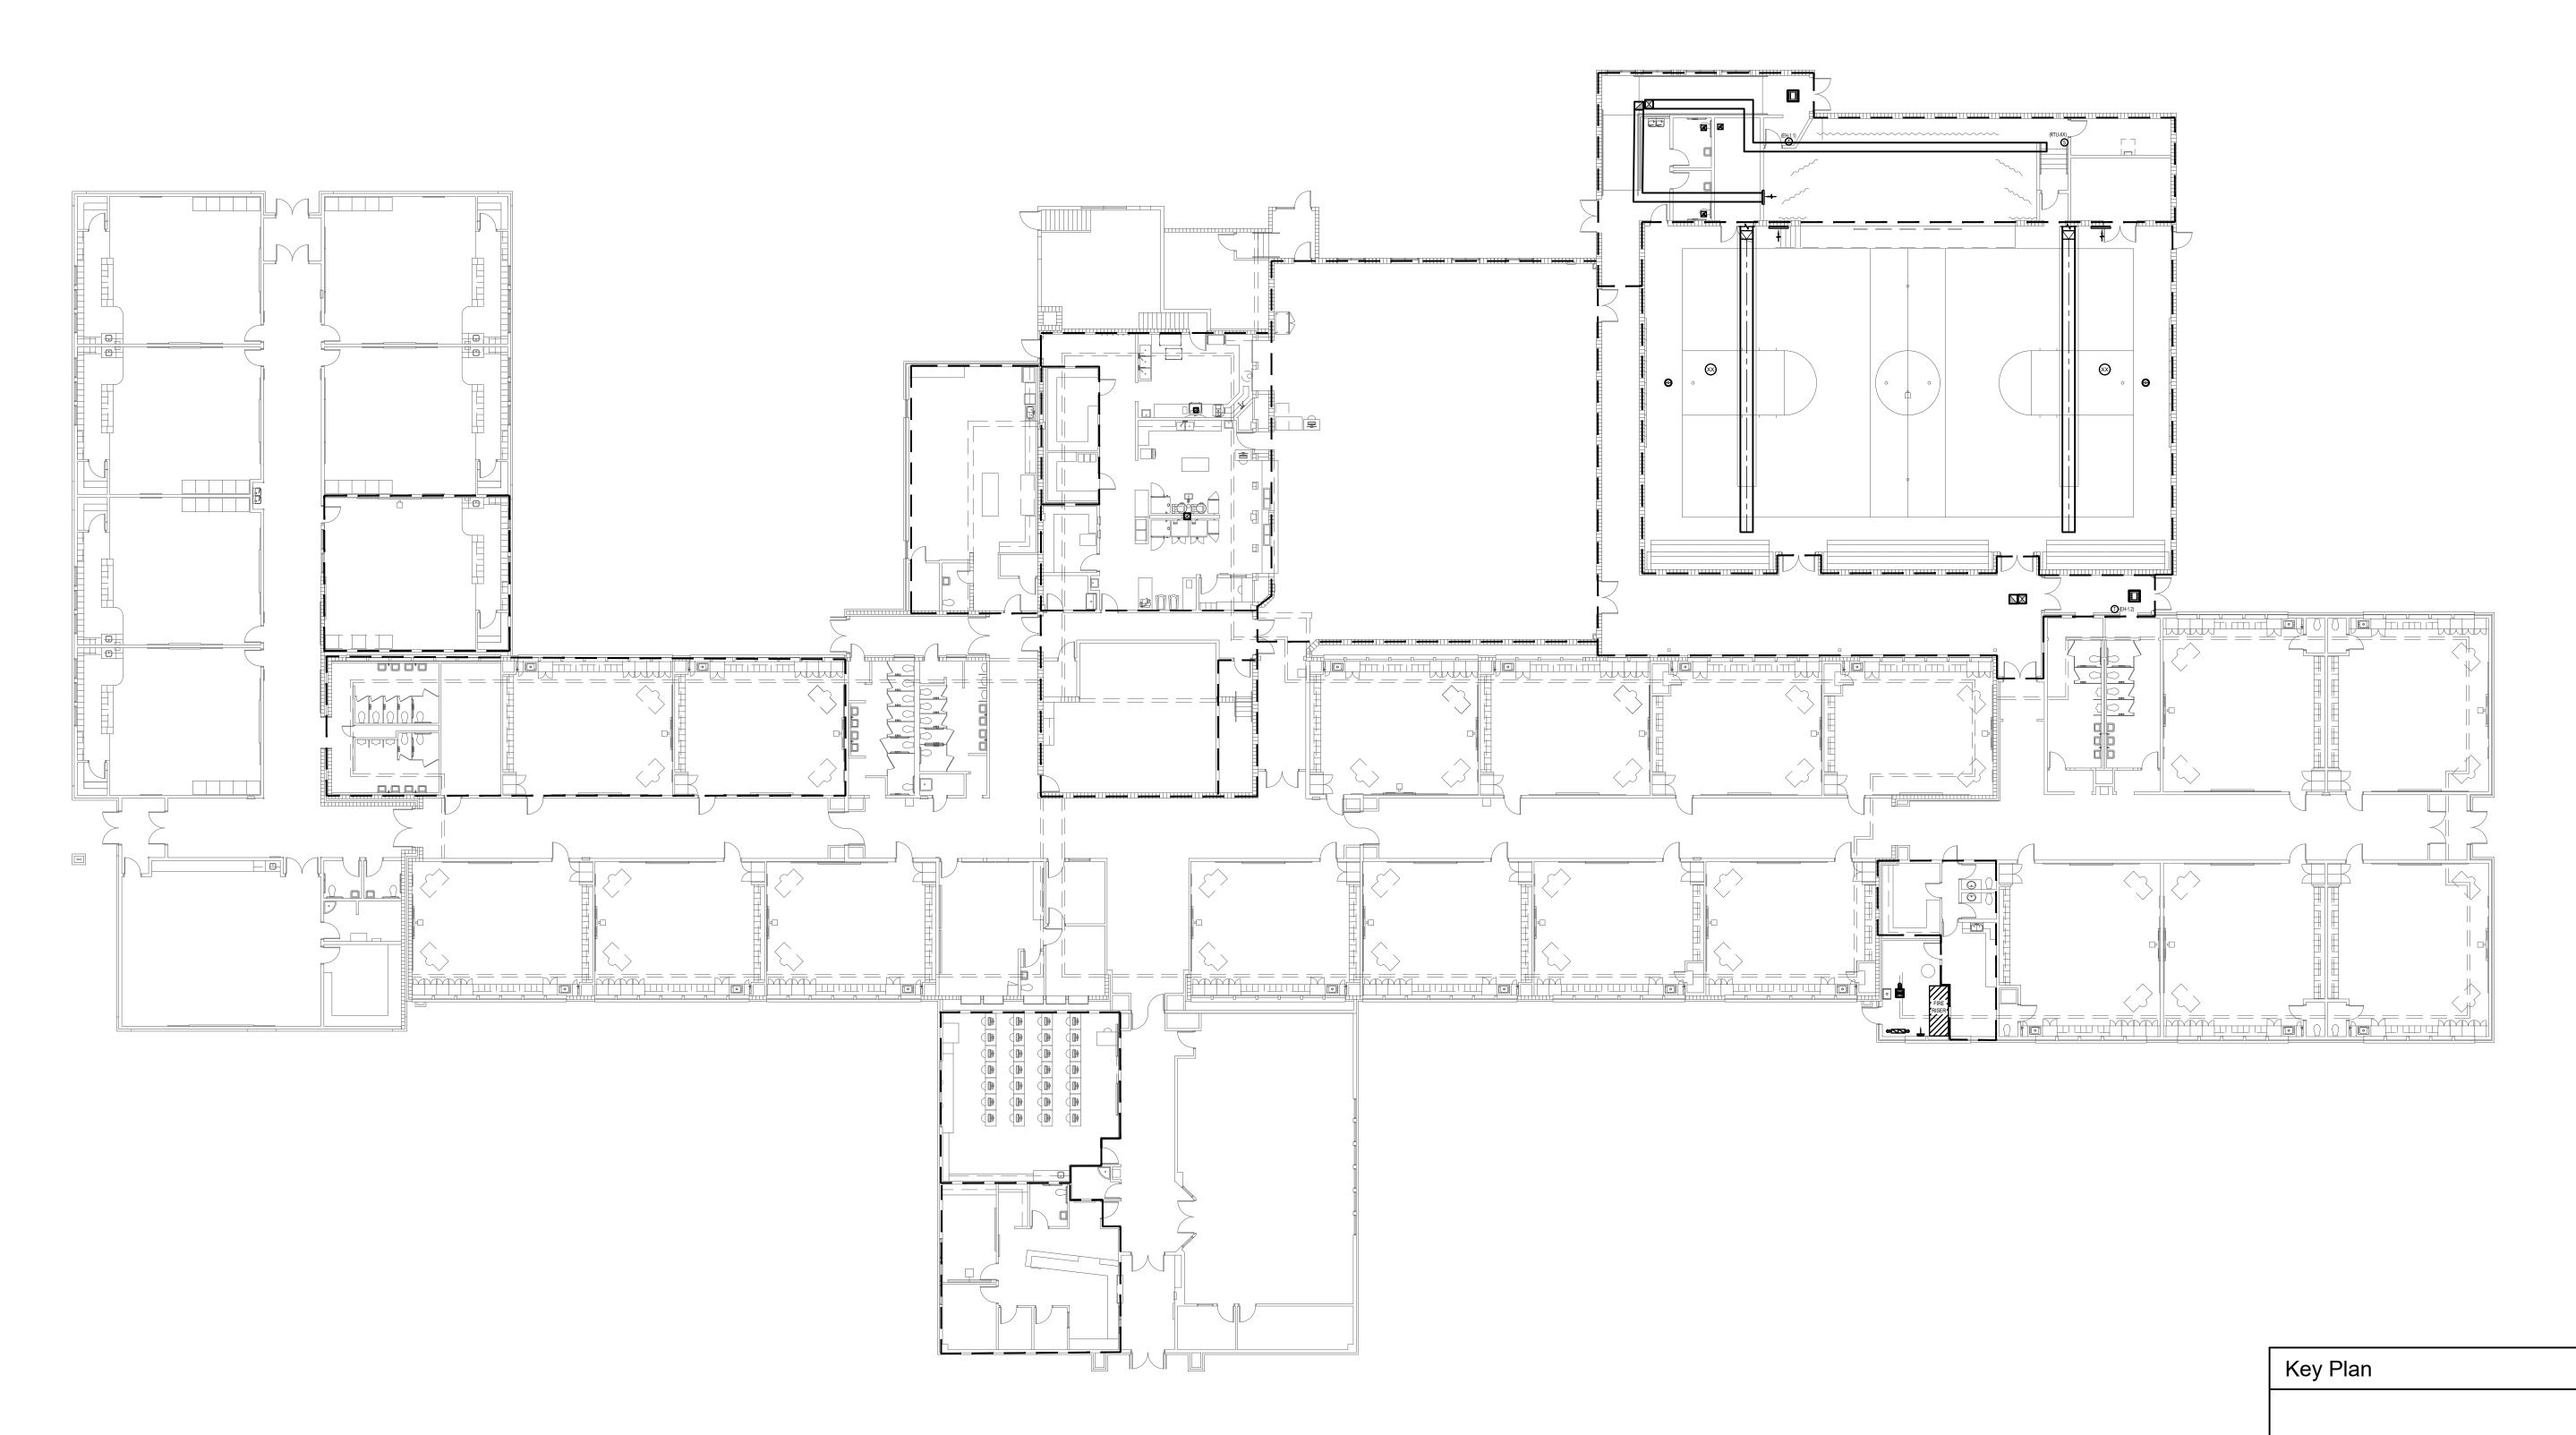
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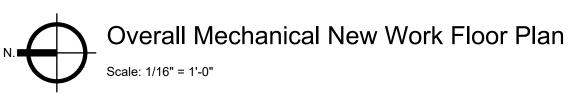
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Design Development

Design Development

M-1.5







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Area'A'

Area 'D'

North Not to Scale

Area'B'

Area 'E'

Design Development

DRAWING NO.

M-2.0



Mechanical New Work Plan - Area 'A'

Scale: 1/8" = 1'-0"

#### KEYED NOTES:

# SYMBOL USED FOR NOTE CALLOUT.

1. KEYNOTES



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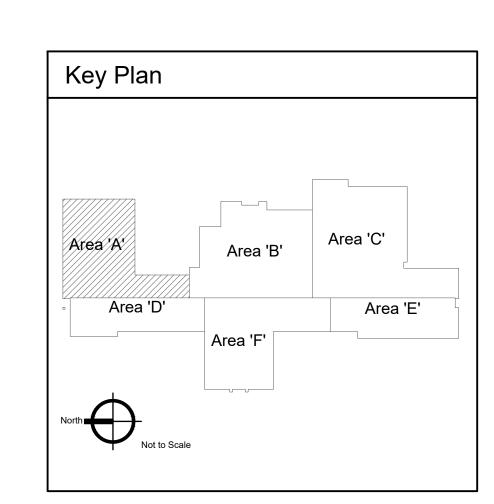


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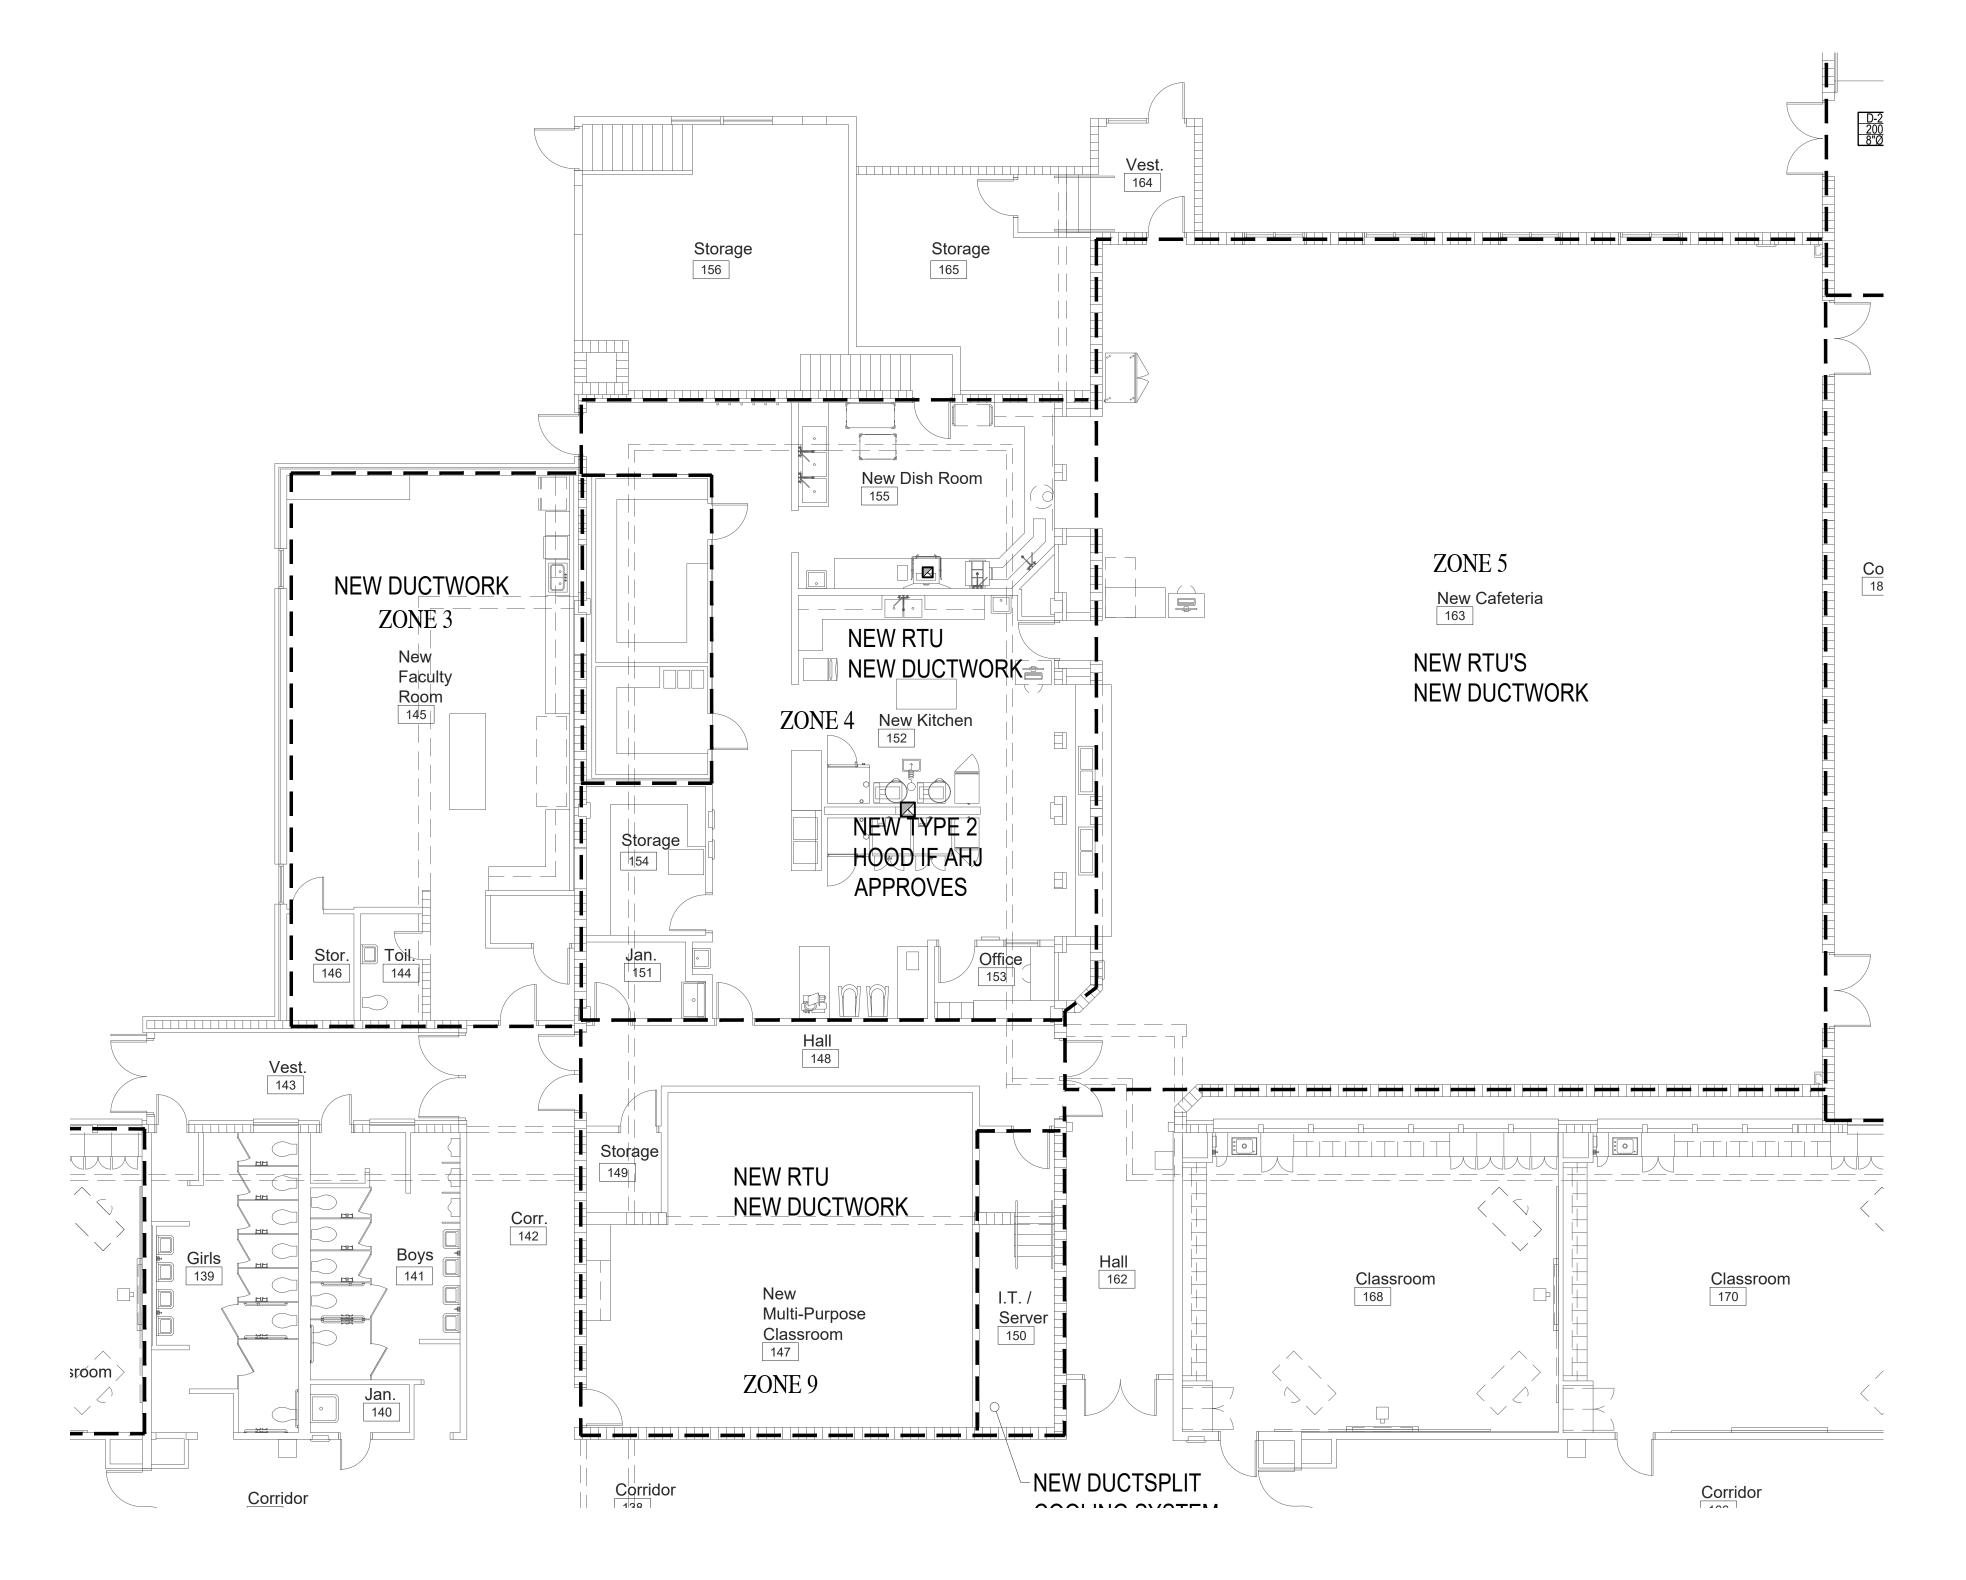


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Design Development

DRAWING NO.



N. Mechanical New Work Plan - Area 'B'

Scale: 1/8" = 1'-0"

# SYMBOL USED FOR NOTE CALLOUT.

1. KEYNOTES



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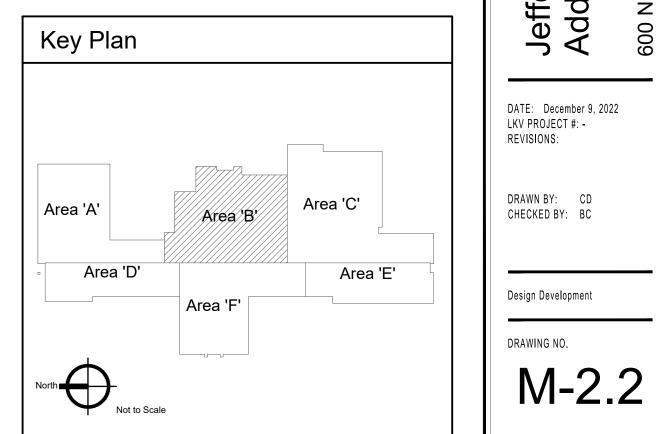


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Mechanical New Work Plan - Area 'C'

#### KEYED NOTES:

# SYMBOL USED FOR NOTE CALLOUT.

1. KEYNOTES



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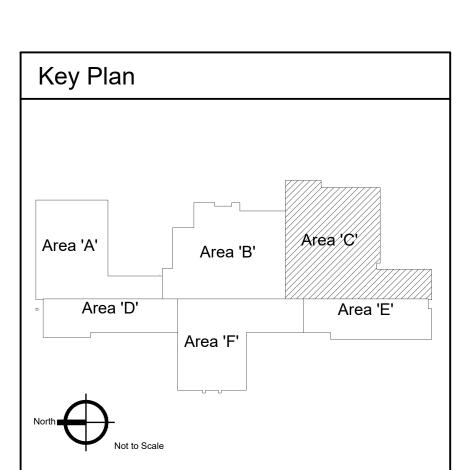


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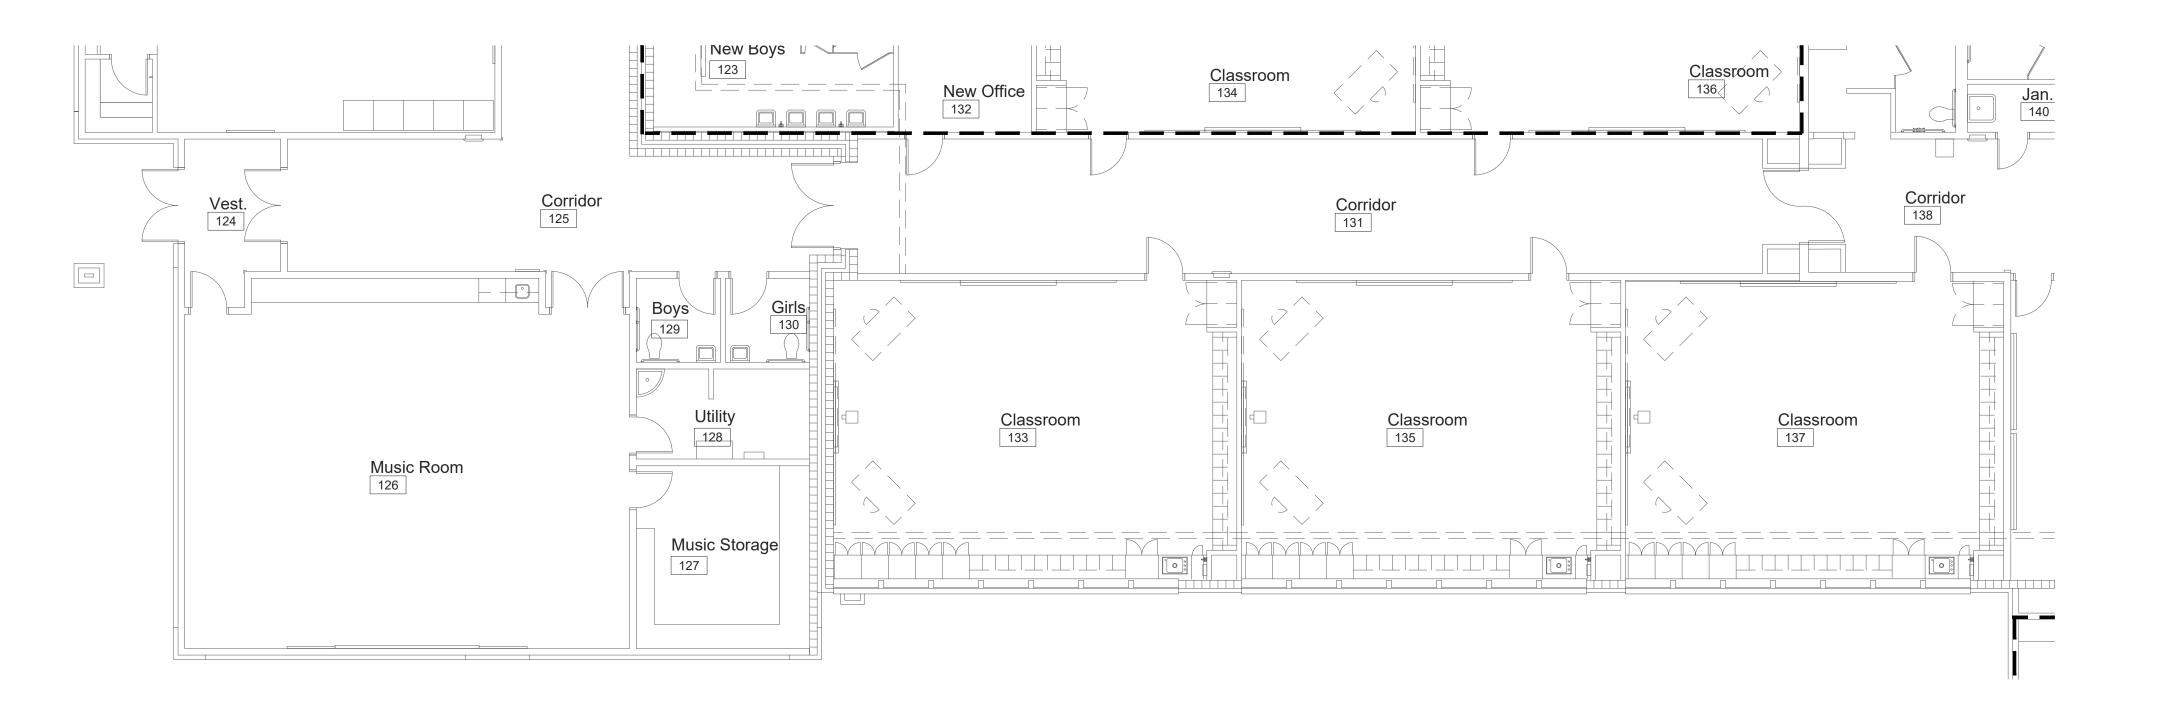


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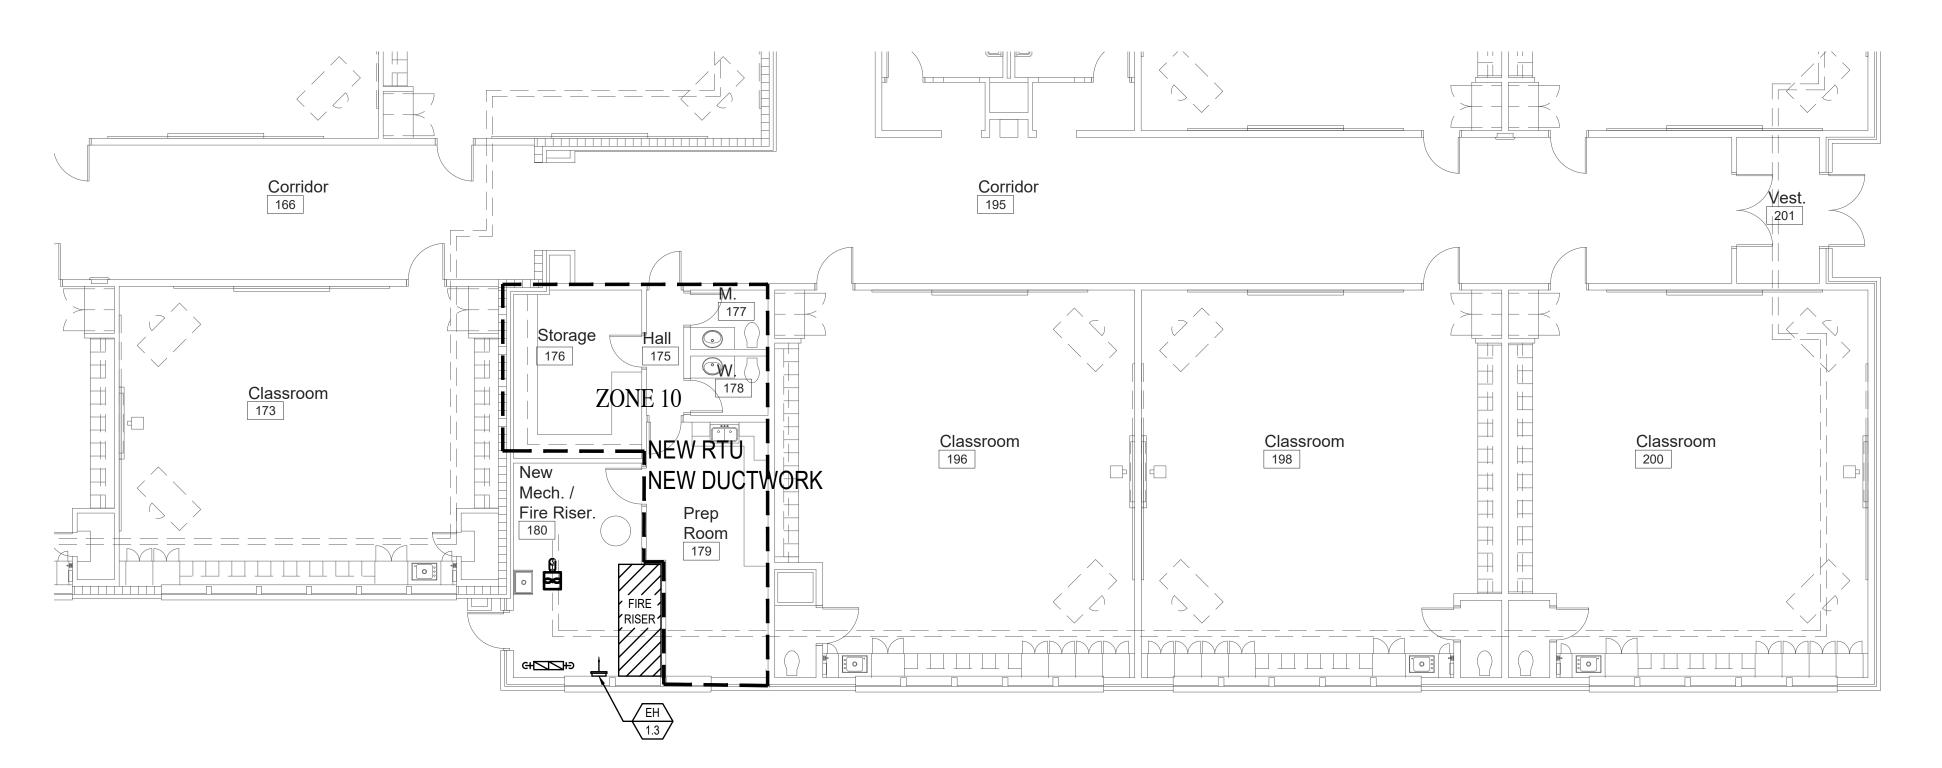
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Design Development

DRAWING NO. M-2.3









# SYMBOL USED FOR NOTE CALLOUT.

1. KEYNOTES



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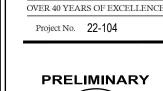
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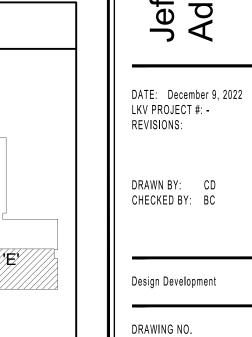
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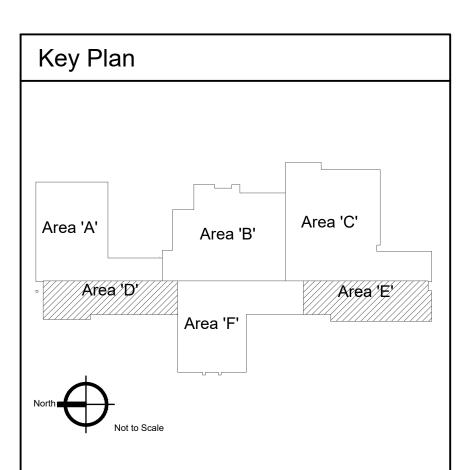





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M-2.4







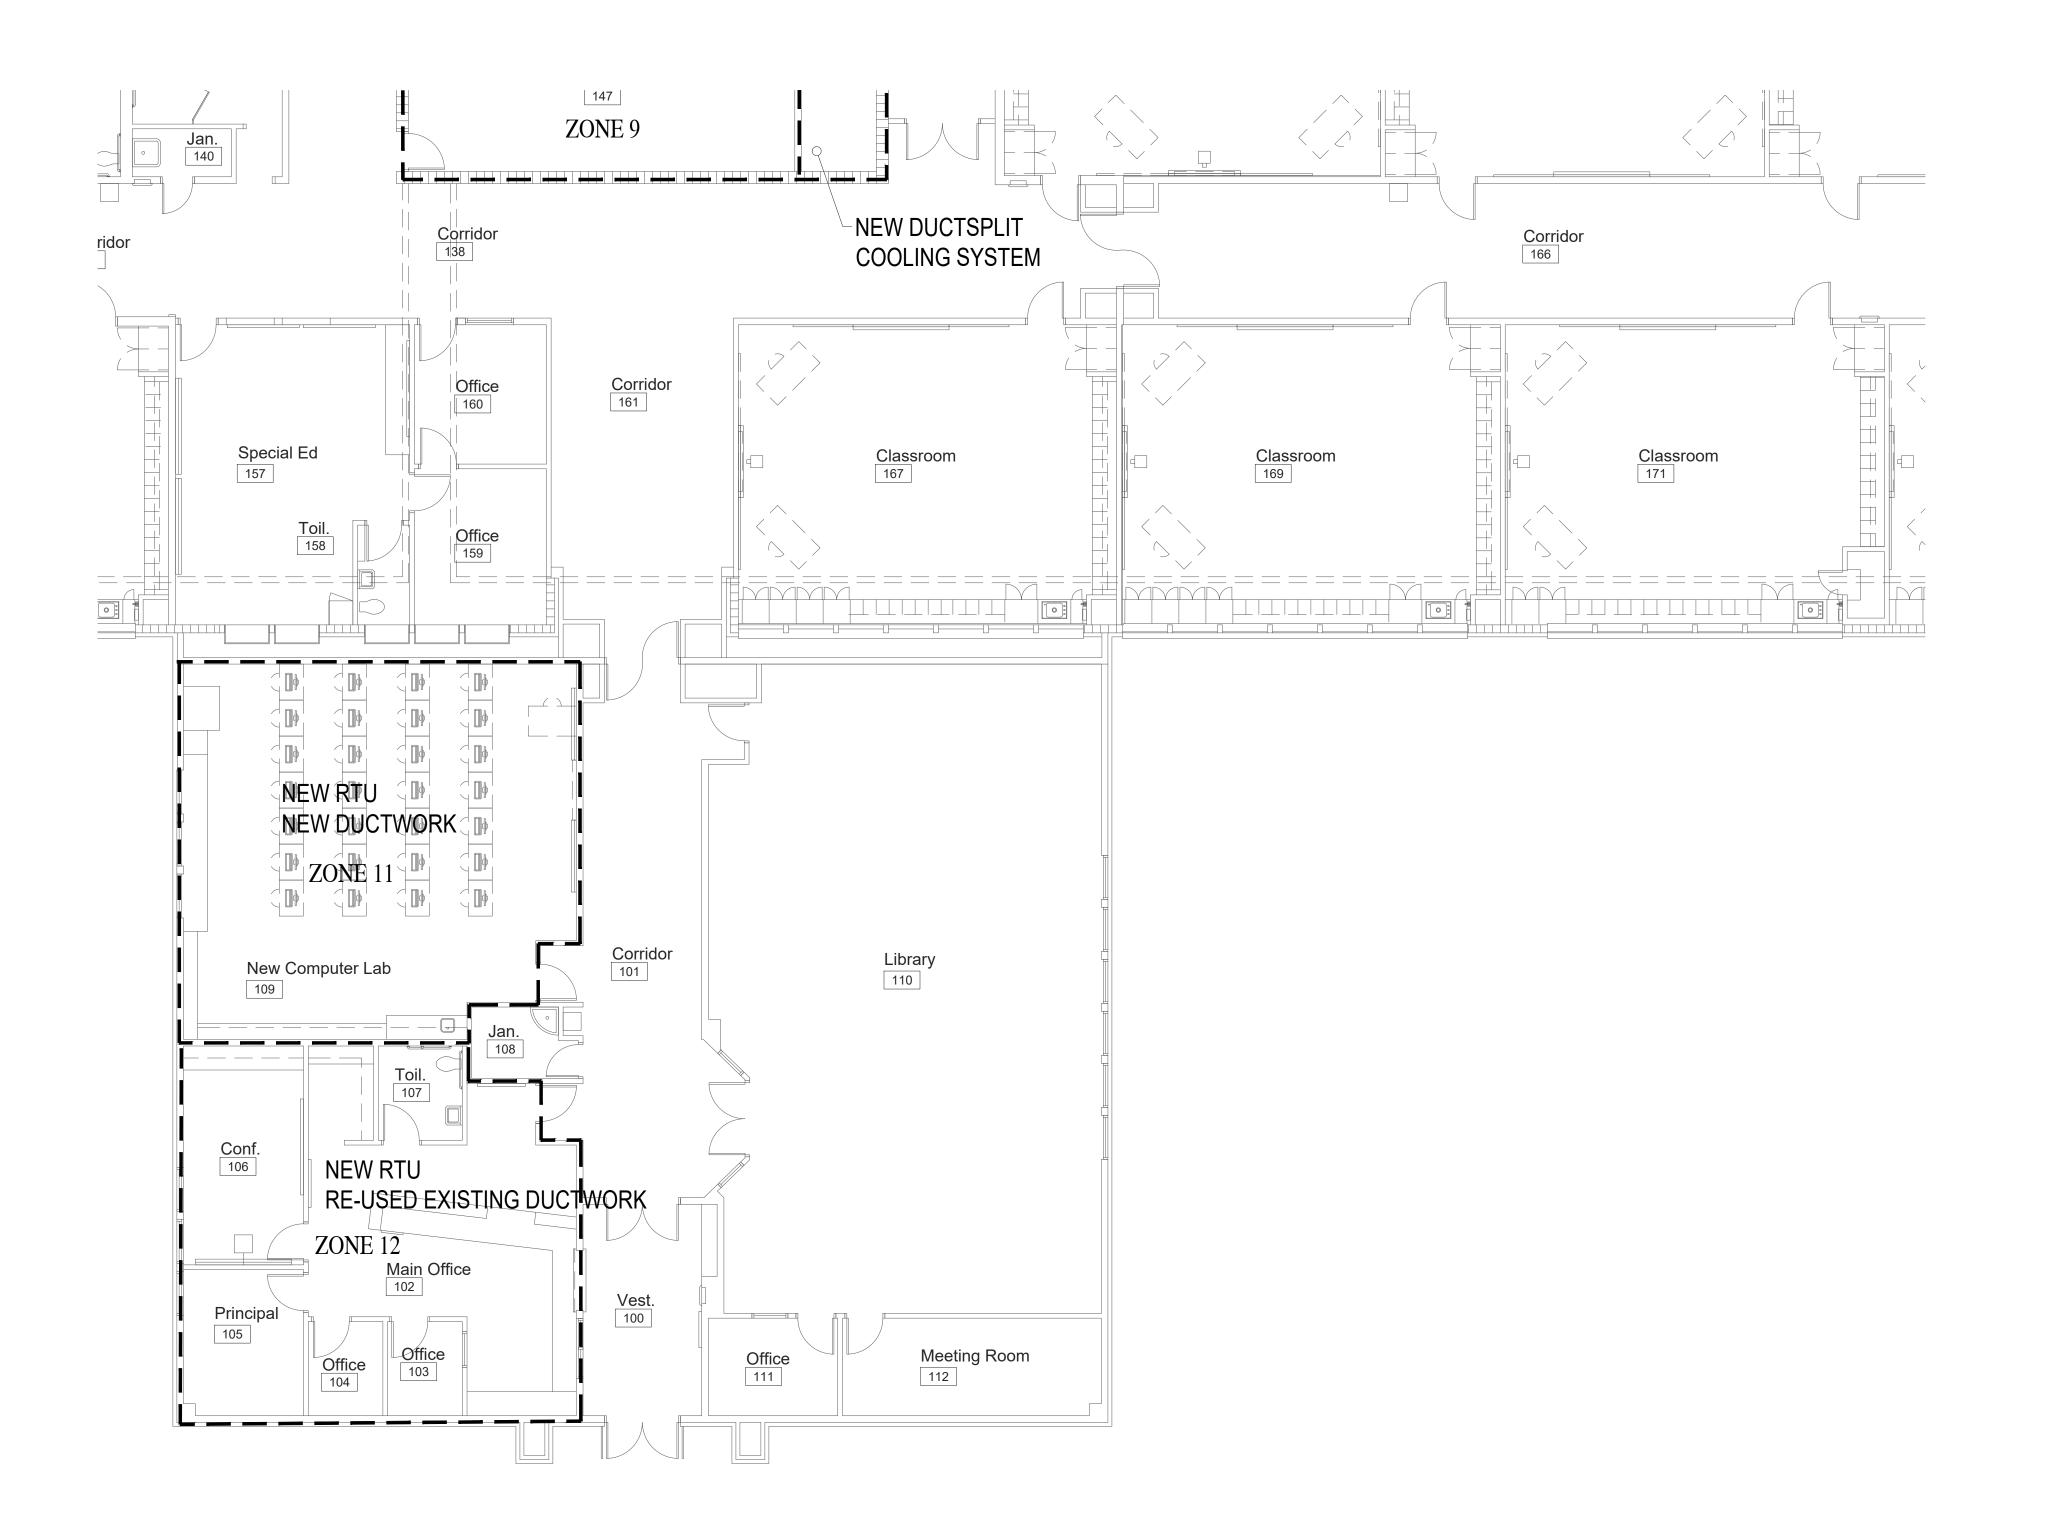

# SYMBOL USED FOR NOTE CALLOUT.

1. KEYNOTES



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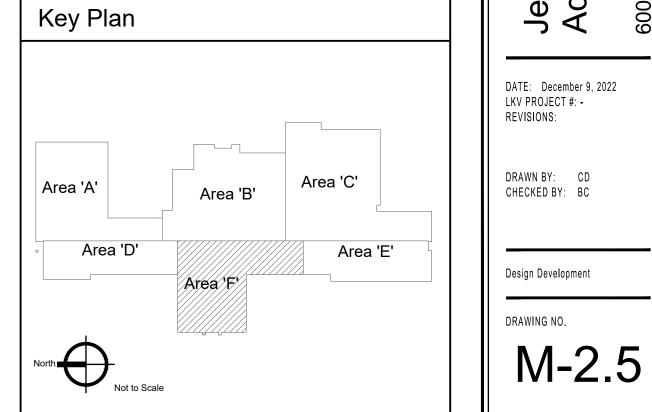


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Project No. 22-104



Jefferson Elementary School Addition and Remodel



Area 'A'

# SYMBOL USED FOR NOTE CALLOUT.

1. KEYNOTES



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Jefferson Elementary School Addition and Remodel

DATE: December 9, 2022 LKV PROJECT #: -REVISIONS:

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Design Development

DRAWING NO.

M-2.6

# SYMBOL USED FOR NOTE CALLOUT.

1. KEYNOTES

Area 'A'

Area 'D'

Area'B'

Area'E'

A R C H I T E C T S

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Project No. 22-104

PRELIMINARY




Jefferson Elementary School Addition and Remodel

DATE: December 9, 2022 LKV PROJECT #: -REVISIONS:


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Design Development

DRAWING NO.



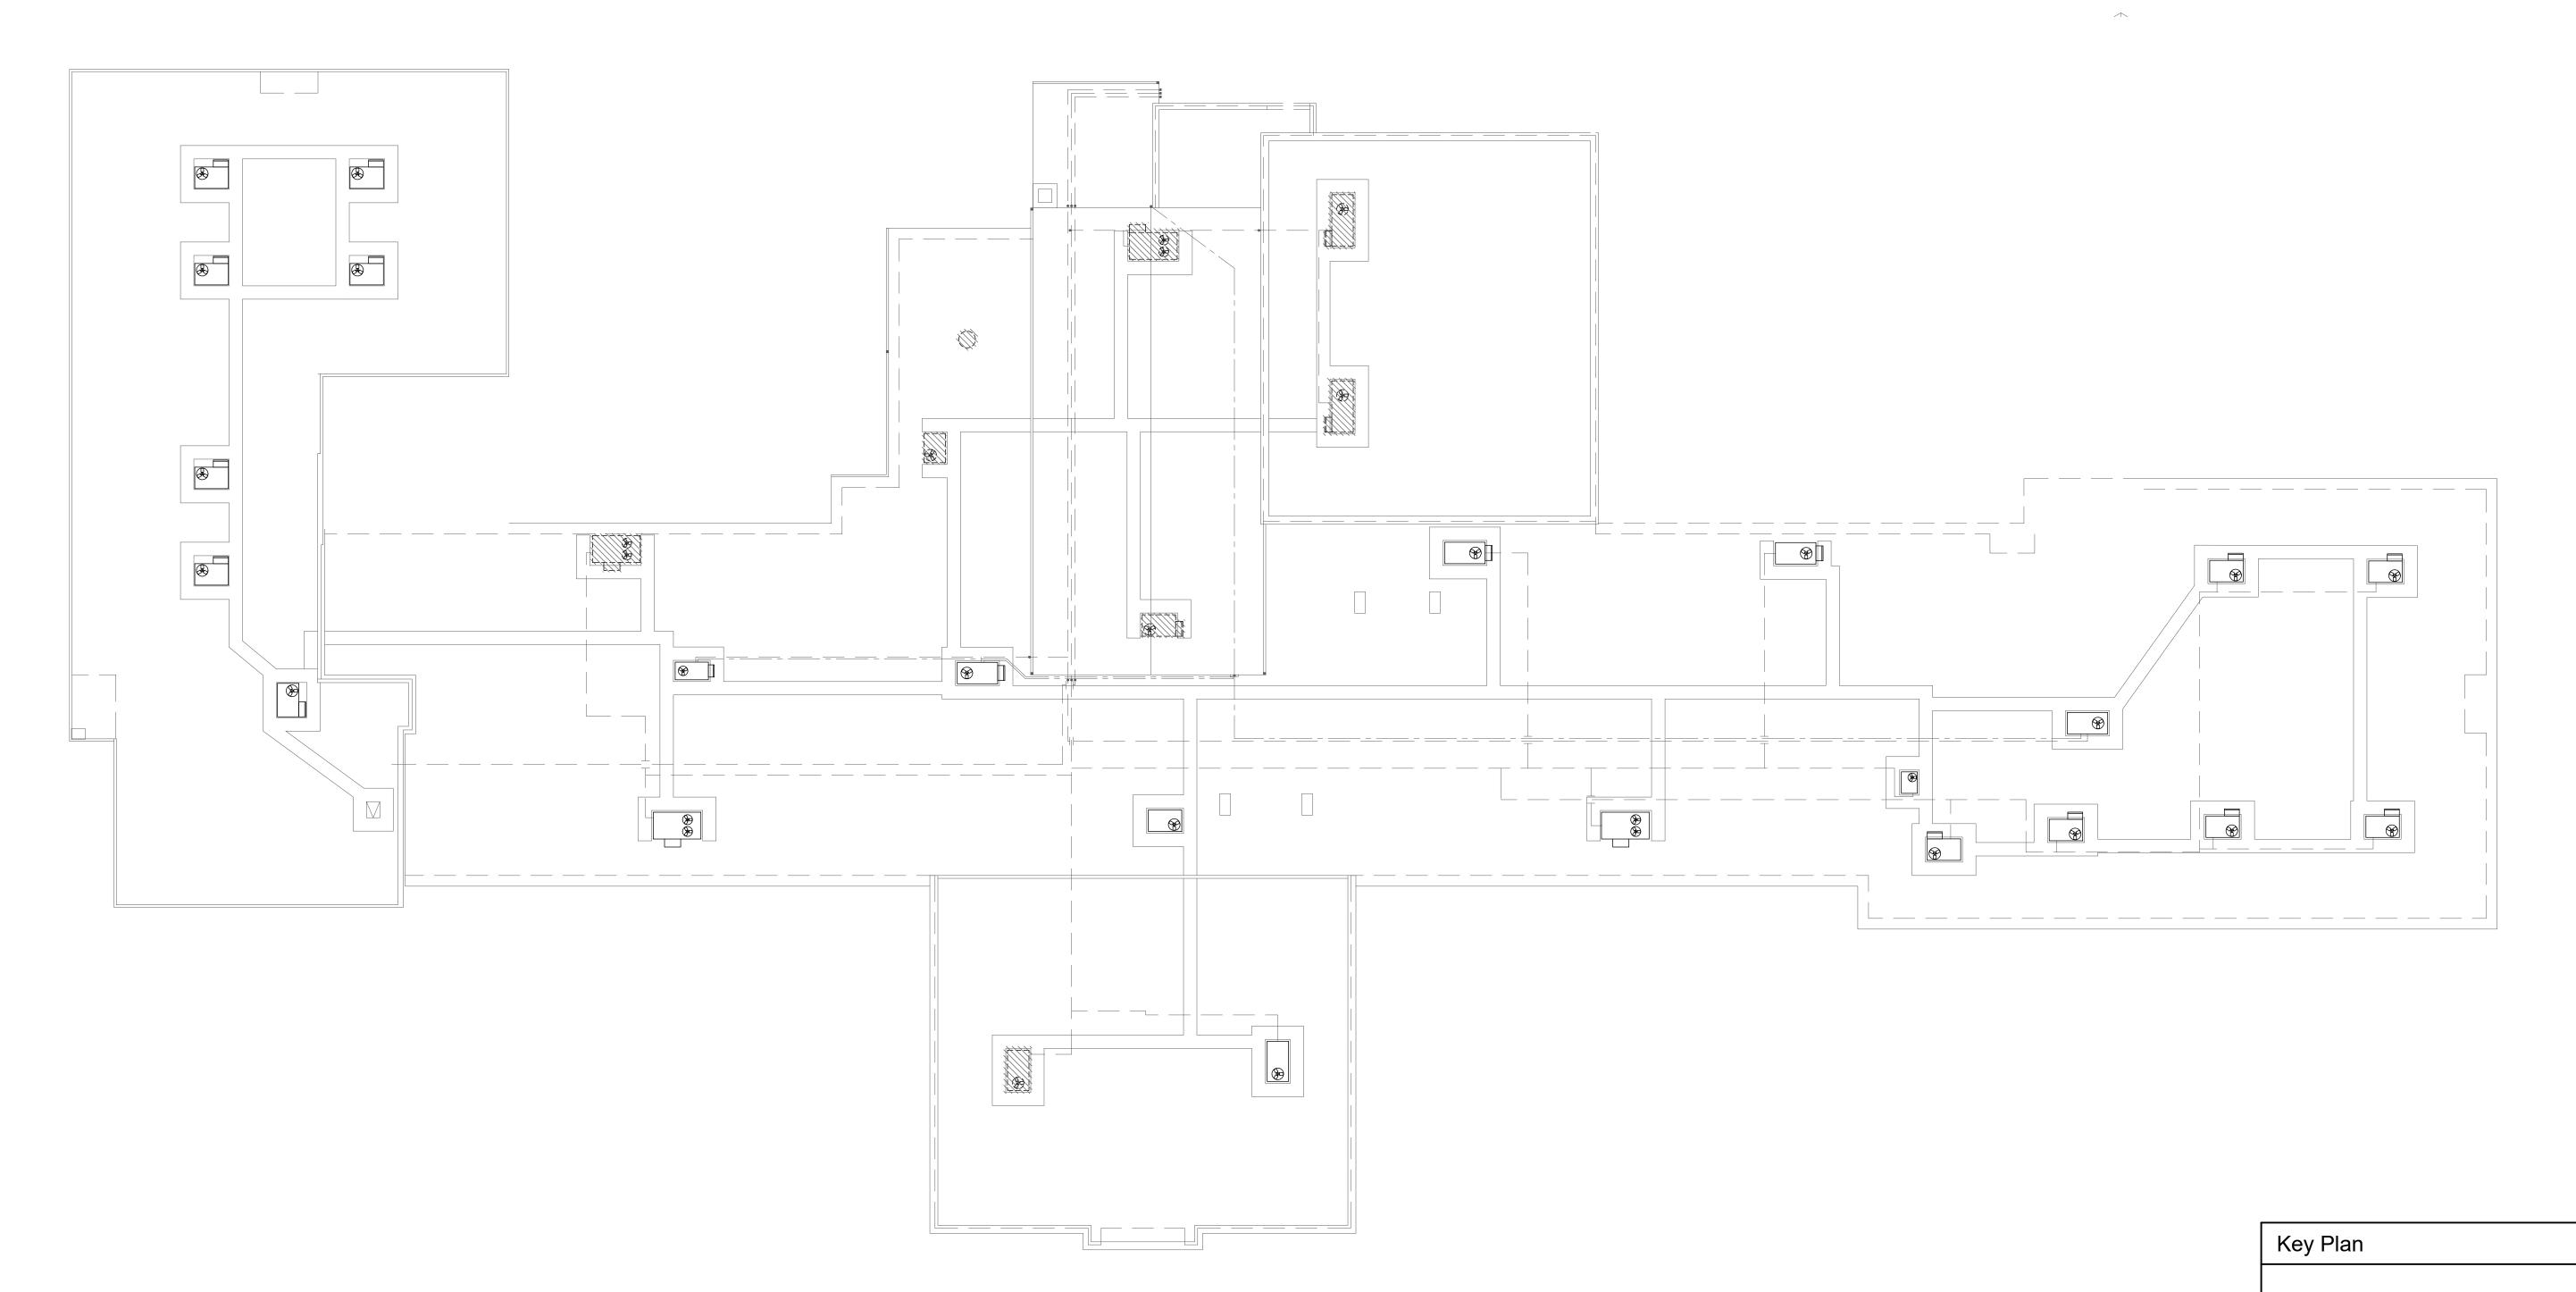

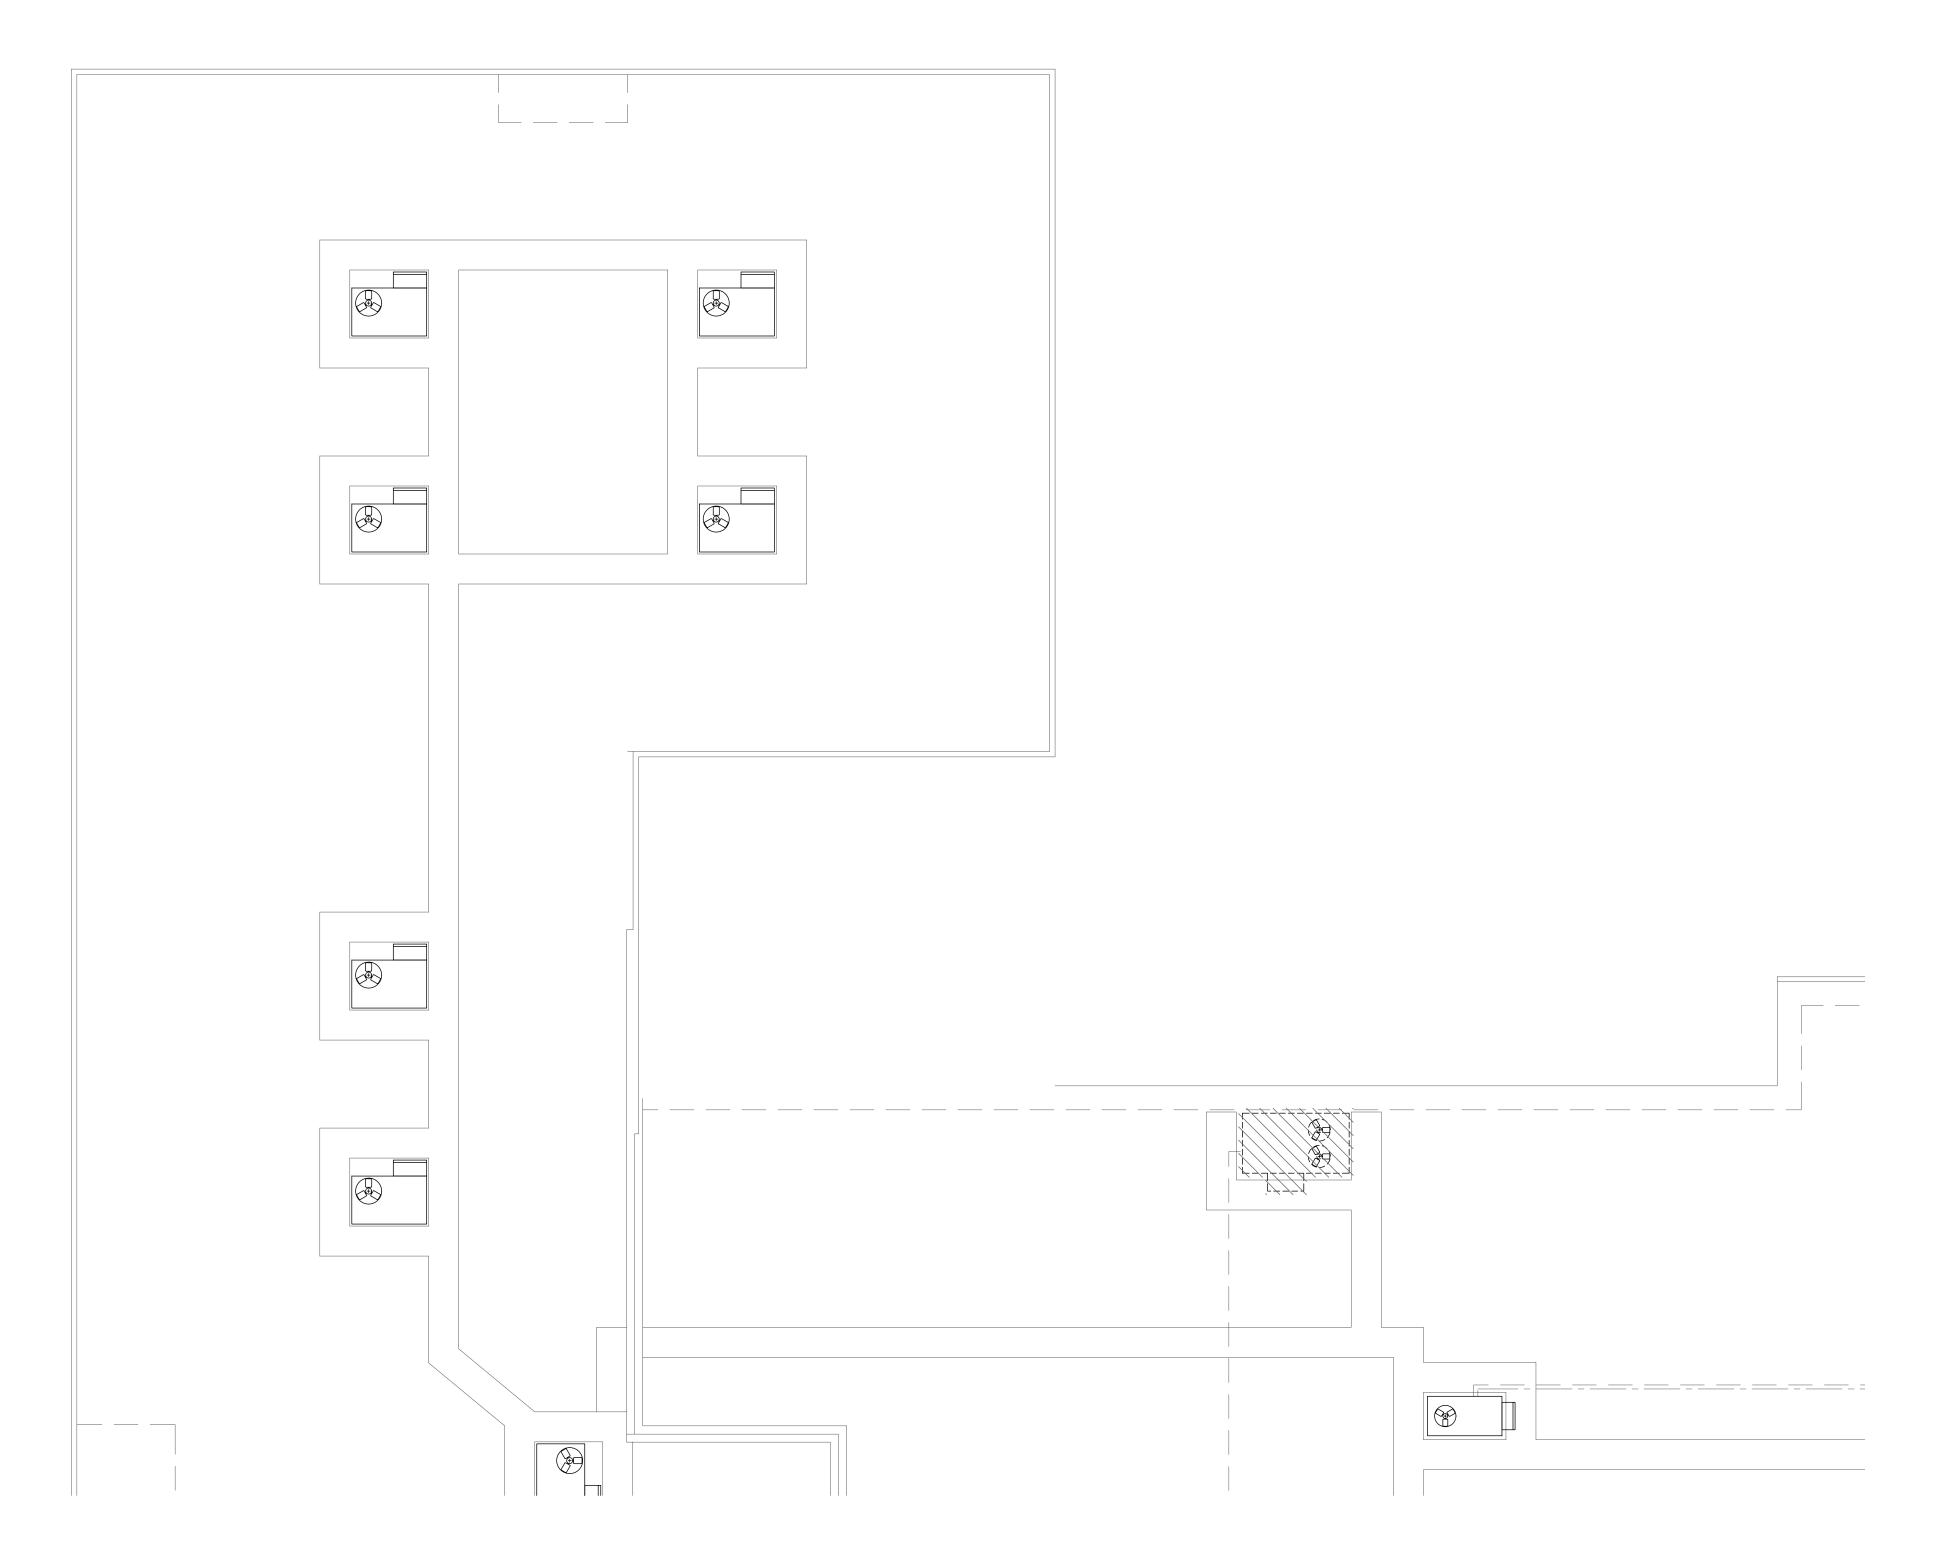

Mechanical Demolition Roof Plan - Area 'A'

# **KEYED NOTES:**

# SYMBOL USED FOR NOTE CALLOUT.

1. KEYNOTES



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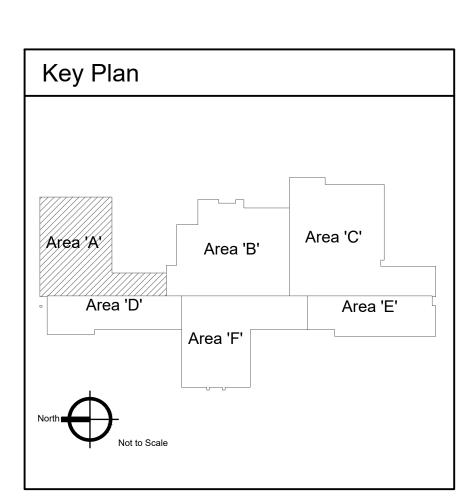


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Jefferson Elementary School Addition and Remodel




600 N. Fillmore Street,

DATE: December 9, 2022 LKV PROJECT #: -REVISIONS:

DRAWN BY: CD CHECKED BY: BC

Design Development

DRAWING NO.

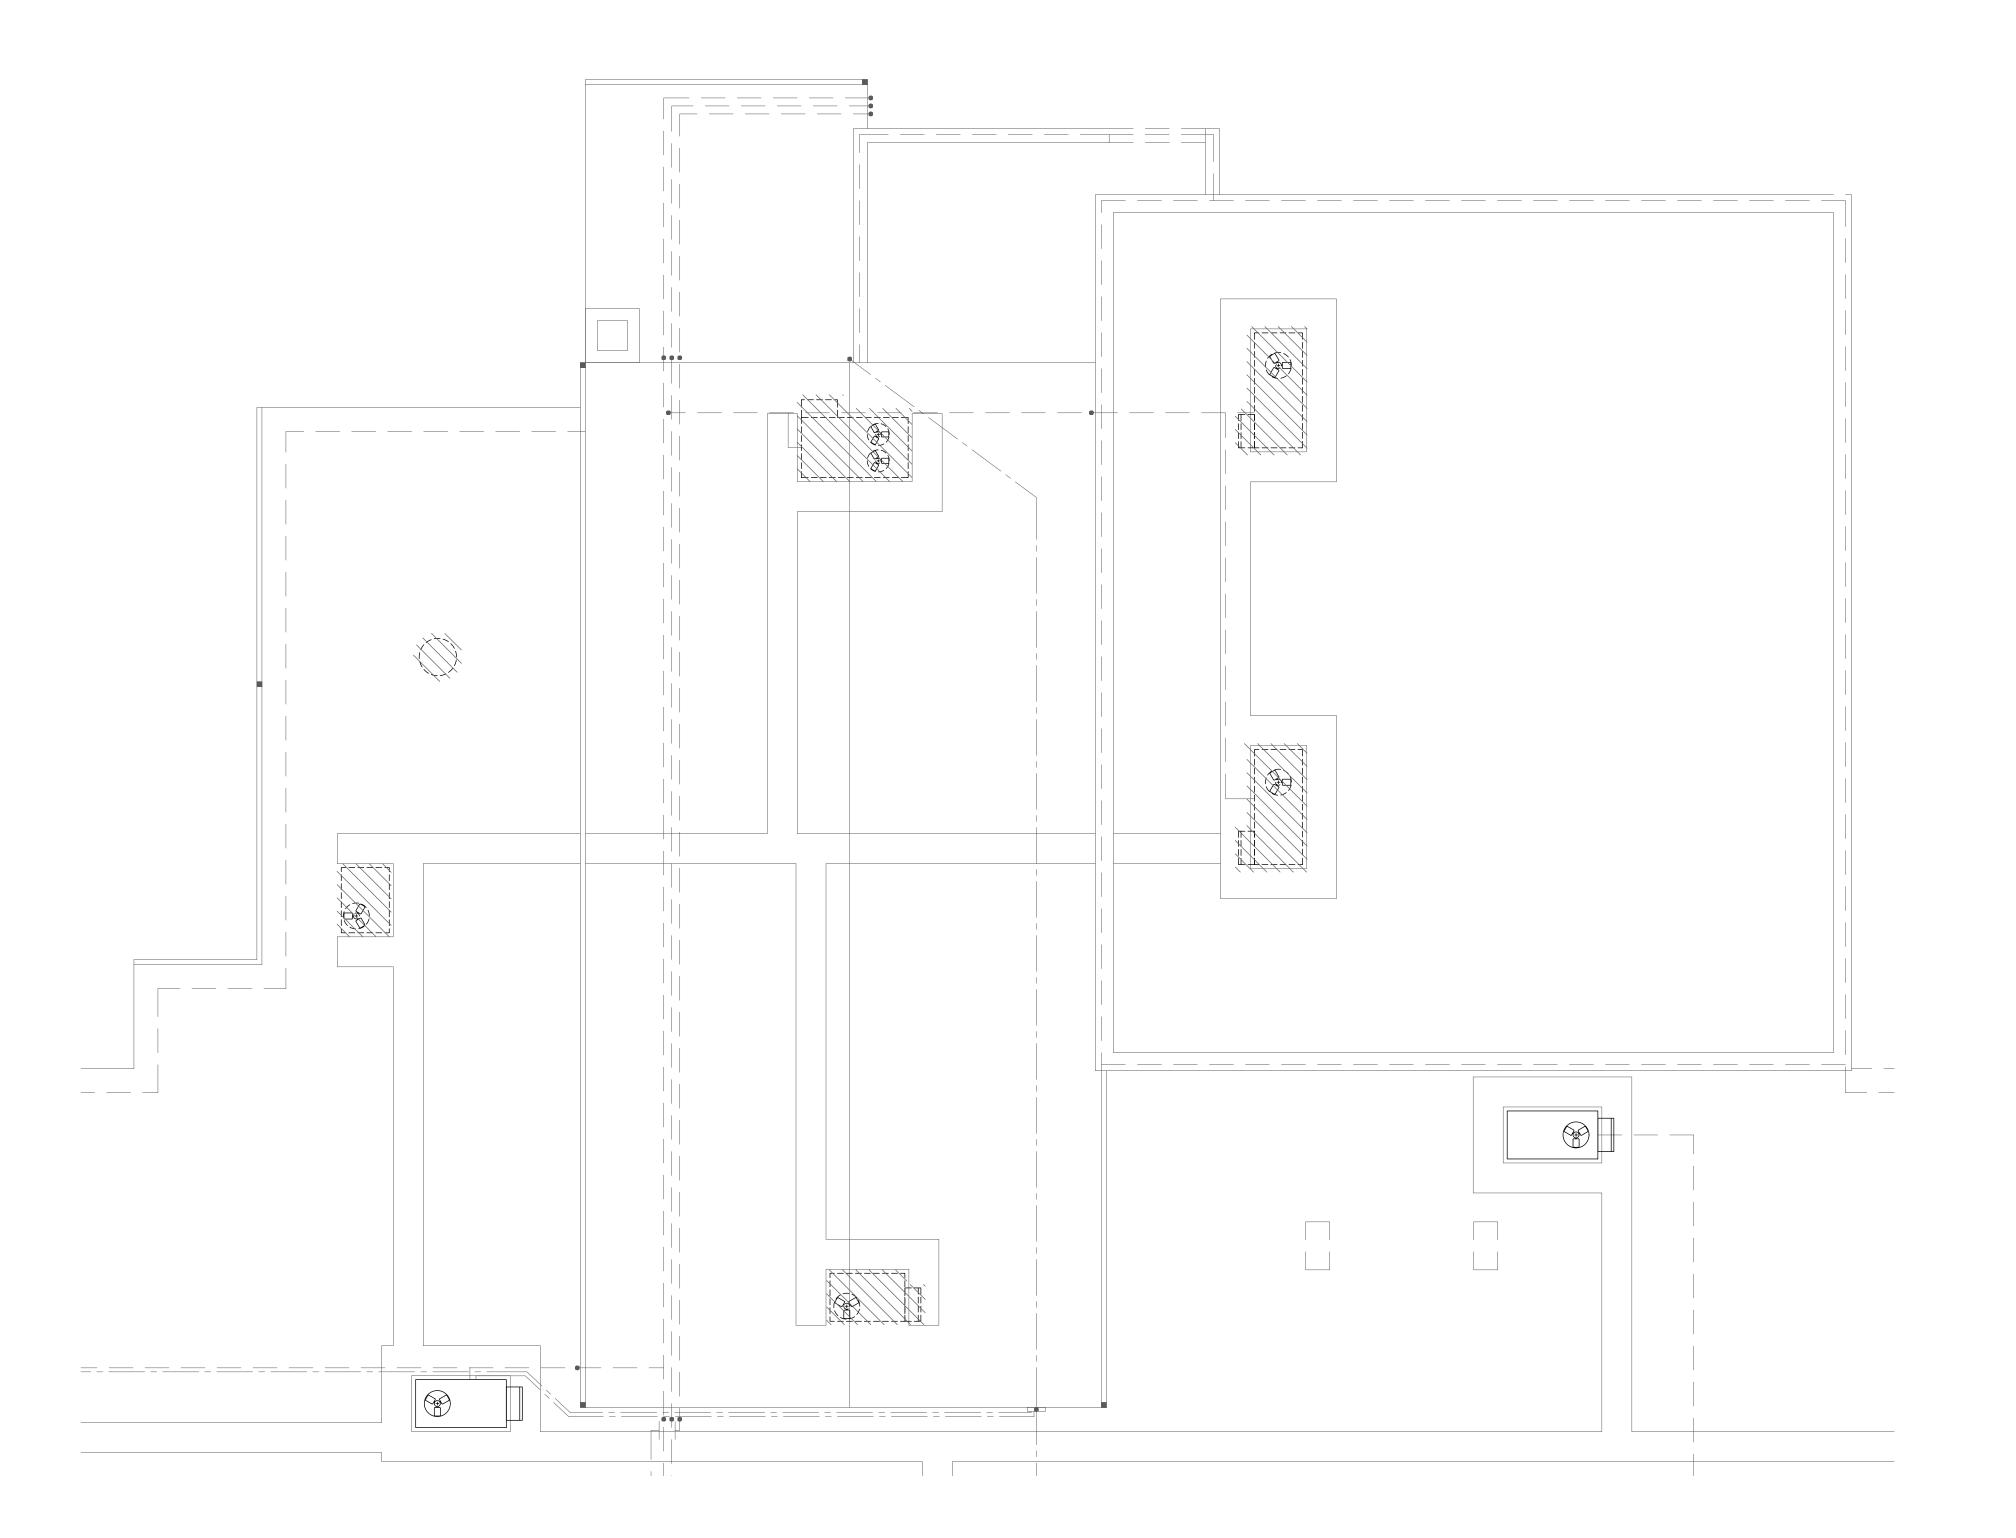

Mechanical Demolition Plan - Area 'B'

Scale: 1/8" = 1'-0"

# **KEYED NOTES:**

# SYMBOL USED FOR NOTE CALLOUT.

1. KEYNOTES



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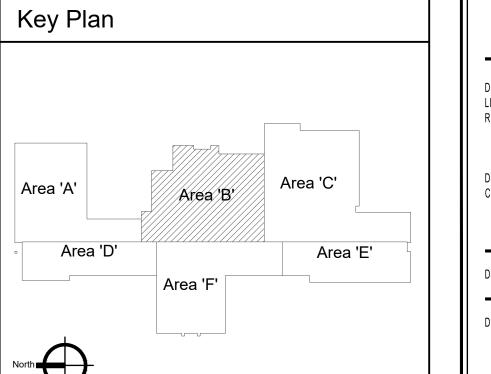
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Project No. 22-104



12/9/2022

Jefferson Elementary School Addition and Remodel



DATE: December 9, 2022 LKV PROJECT #: -REVISIONS:

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Design Development

DRAWING NO.

M-3.2

Mechanical Demolition Roof Plan - Area 'C'

 $\wedge$ 

#### **KEYED NOTES:**

# SYMBOL USED FOR NOTE CALLOUT.

1. KEYNOTES



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OVER 40 YEARS OF EXCELLENCE Project No. 22-104



Jefferson Elementary School Addition and Remodel


Key Plan Area 'A' Area 'B' Area 'D' Area 'E'

DATE: December 9, 2022 LKV PROJECT #: -REVISIONS:

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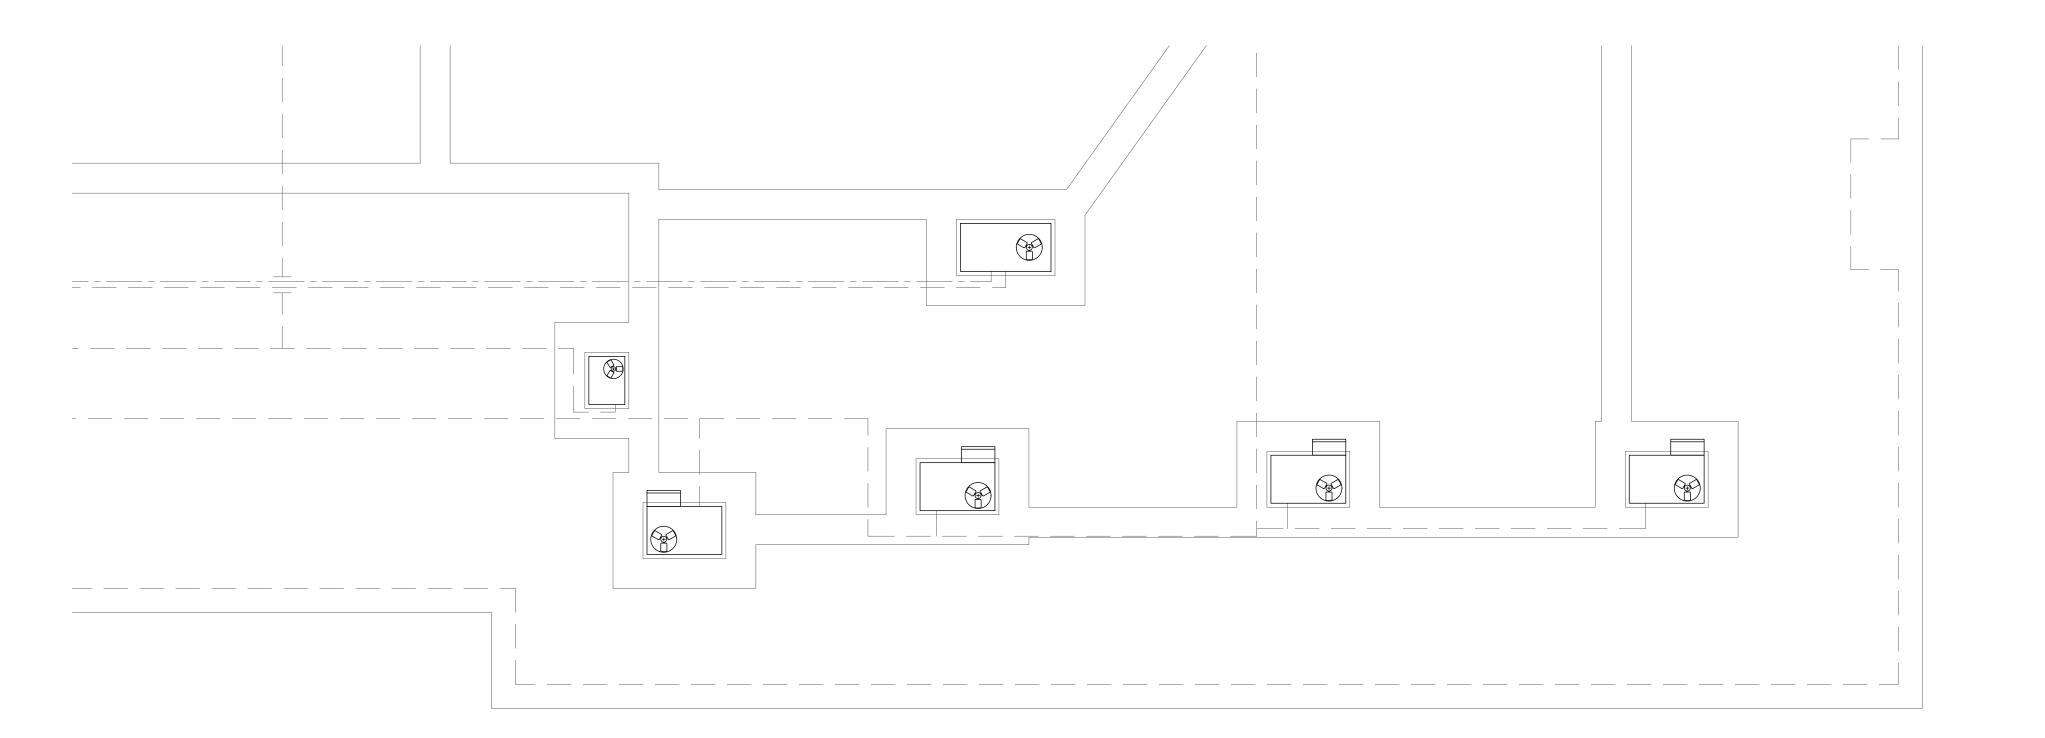
Design Development

DRAWING NO.

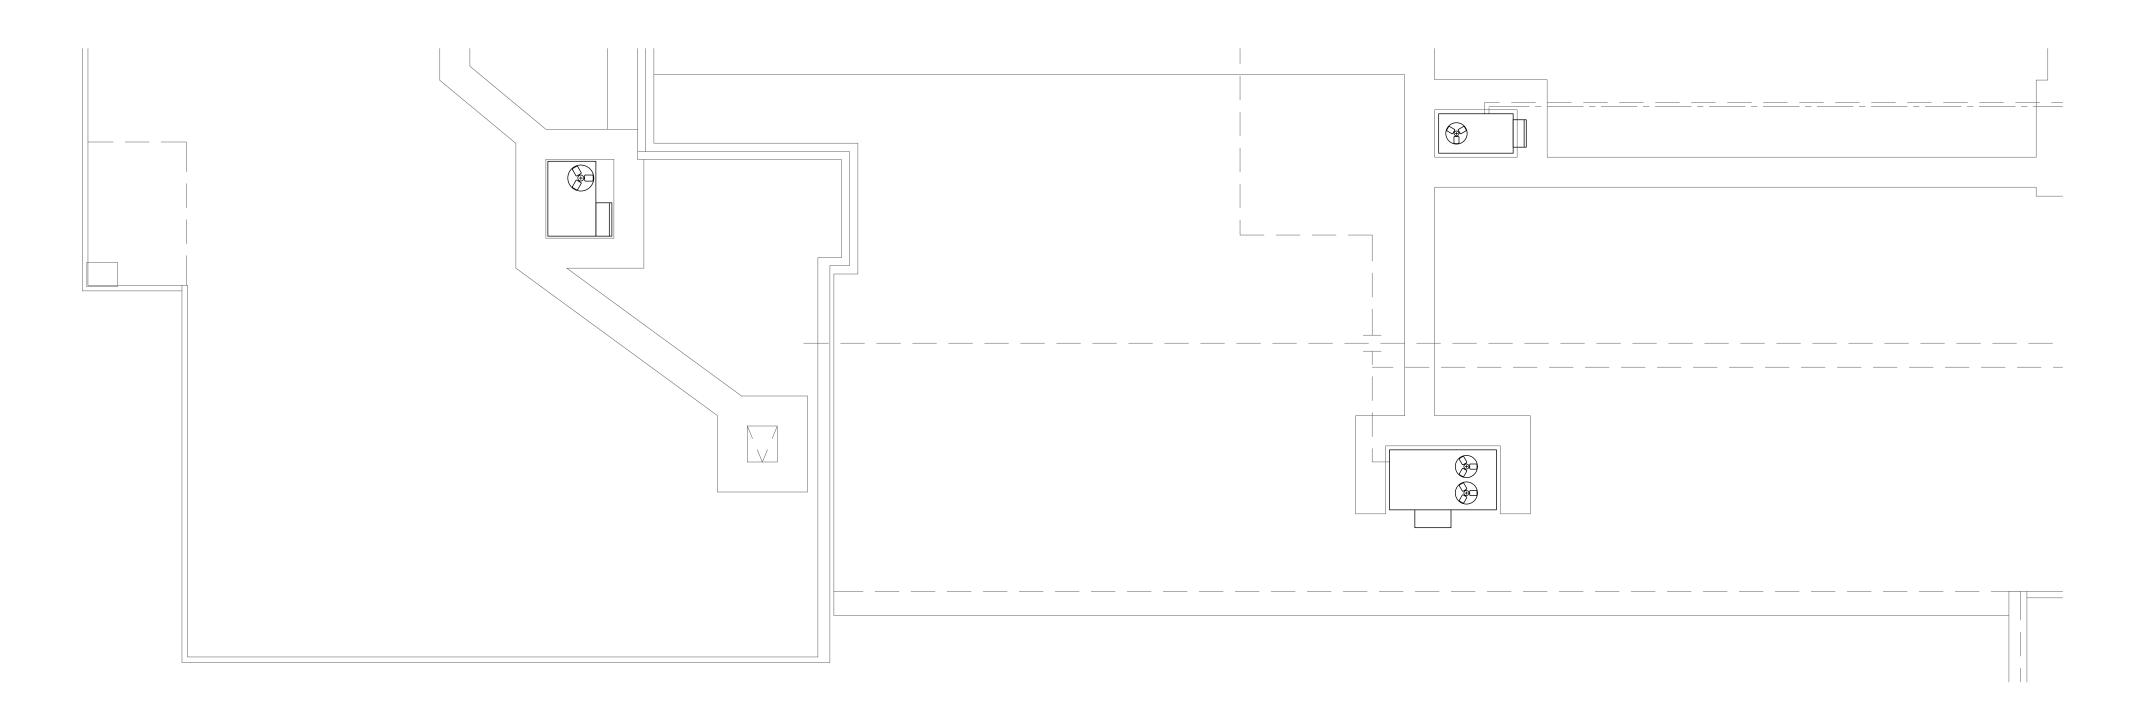

Mechanical Demolition Roof Plan - Area 'D'

Scale: 1/8" = 1'-0"



Mechanical Demolition Roof Plan - Area 'E'

Scale: 1/8" = 1'-0"

# **KEYED NOTES:**

# SYMBOL USED FOR NOTE CALLOUT.

1. KEYNOTES



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Project No. 22-104



Jefferson Elementary School Addition and Remodel

DATE: December 9, 2022
LKV PROJECT #: REVISIONS:


DRAWN BY: CD
CHECKED BY: BC

Design Development

DRAWING NO.

Area 'A'
Area 'B'
Area 'E'

North
Not to Scale

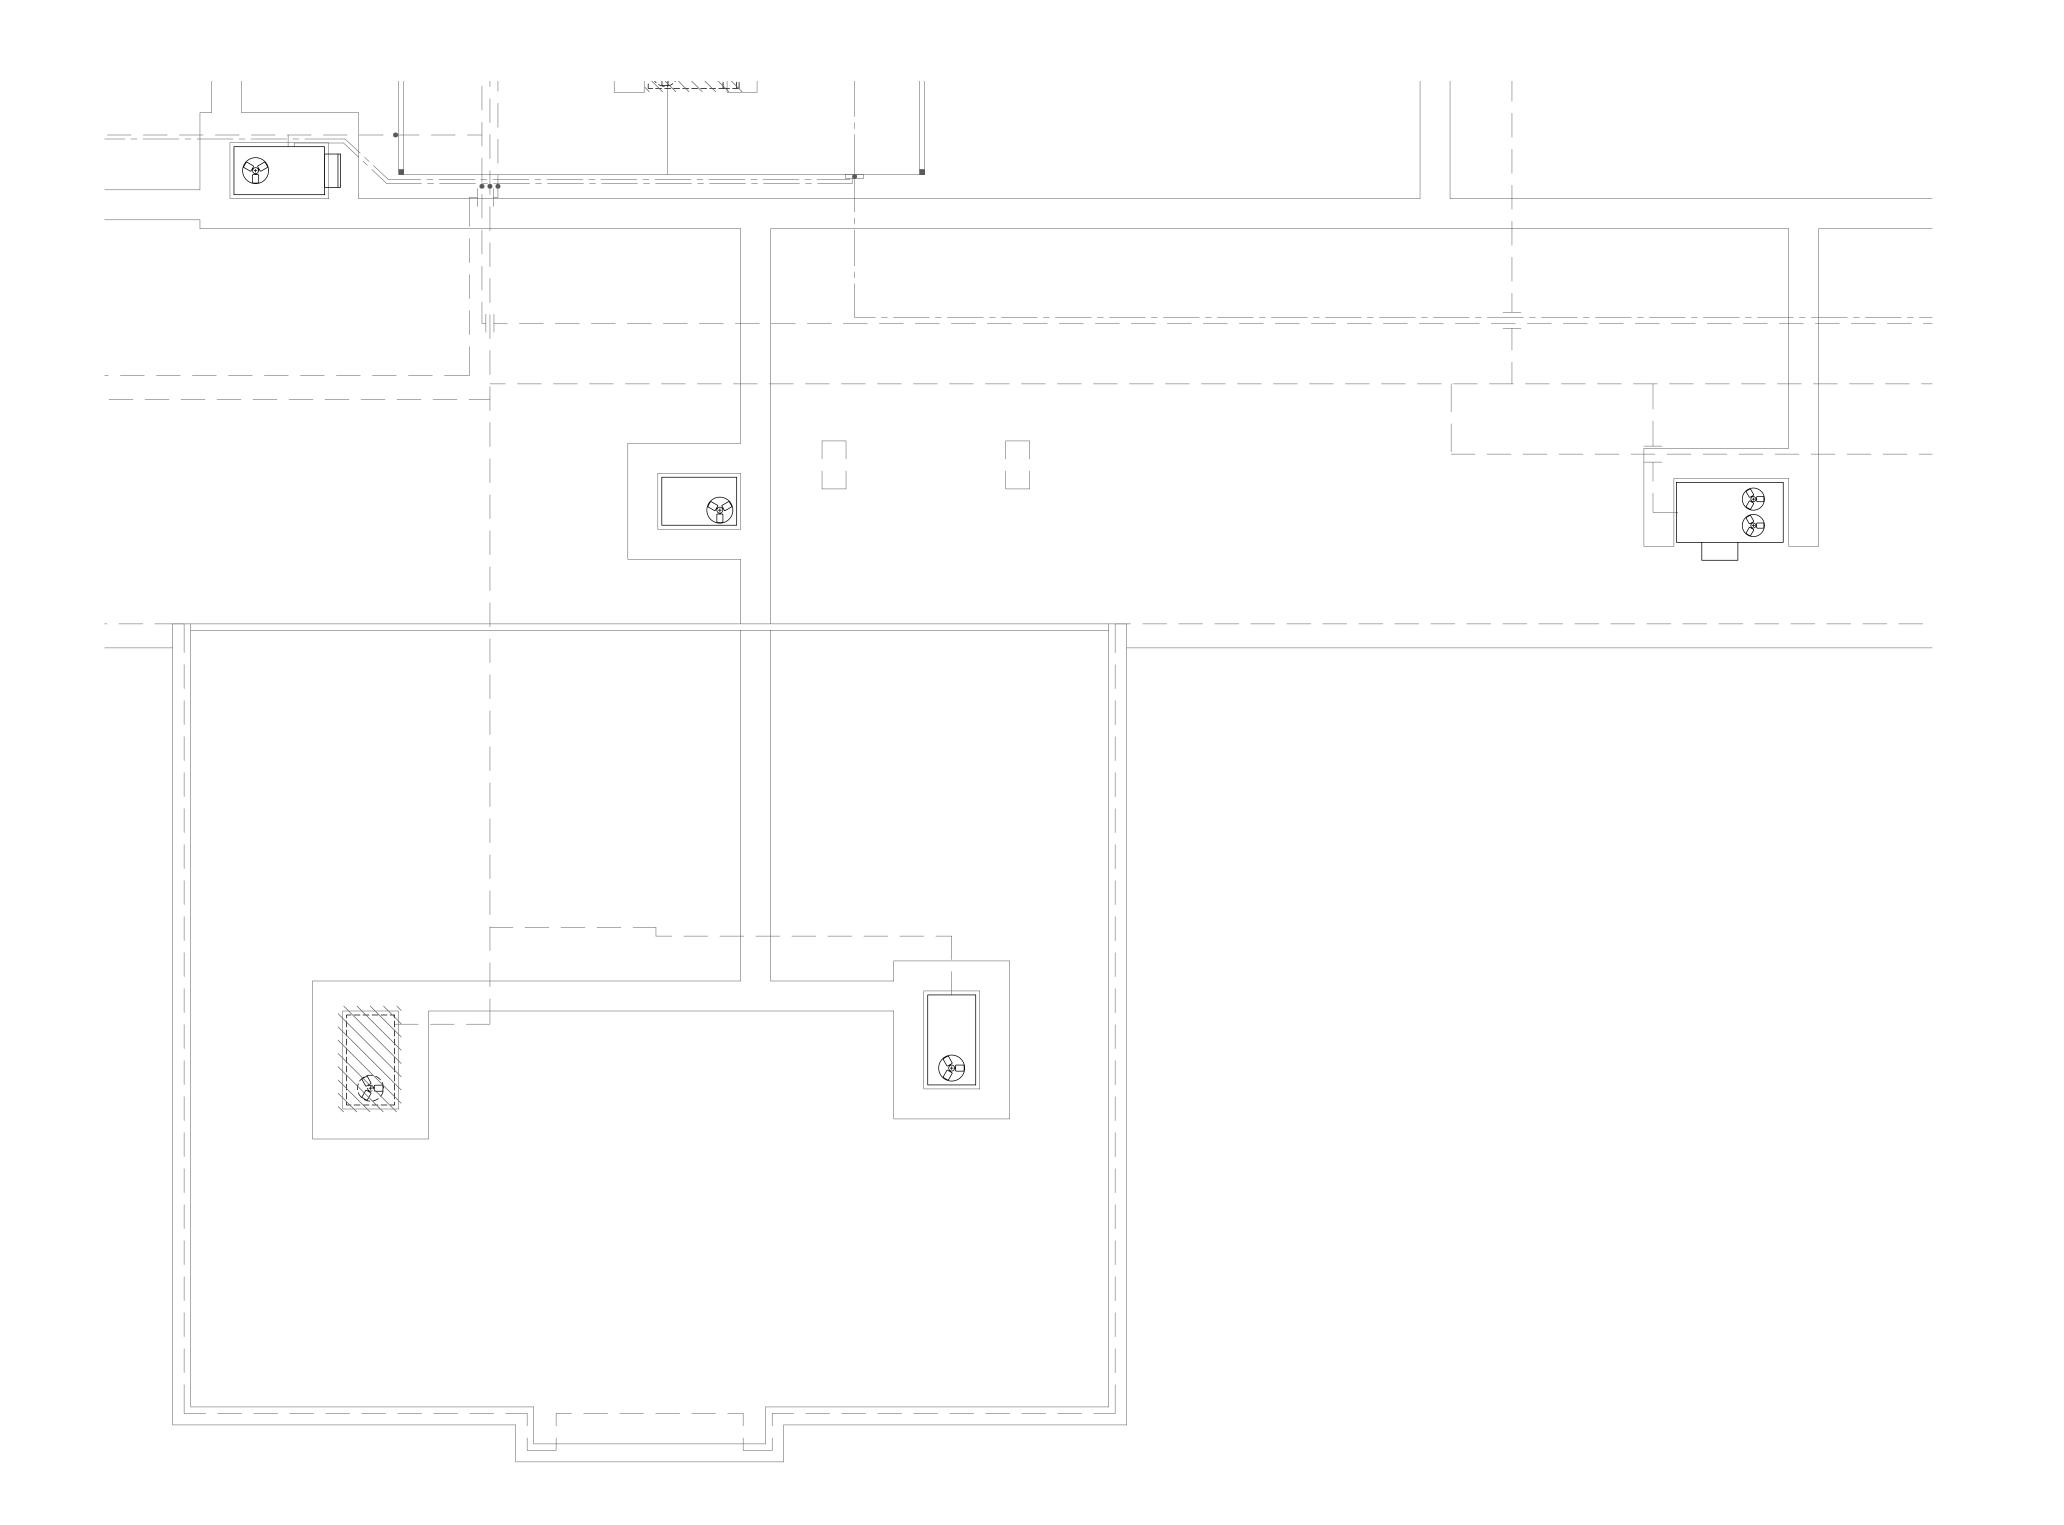

Mechanical Demolition Roof Plan - Area 'F'

Scale: 1/8" = 1'-0"

#### KEYED NOTES:

# SYMBOL USED FOR NOTE CALLOUT.

1. KEYNOTES

Key Plan

Area 'A'

Area 'D'

Area 'B'

Area 'E'



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Project No. 22-104




Jefferson Elementary School Addition and Remodel

DATE: December 9, 2022 LKV PROJECT #: -REVISIONS:

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Design Development

M-3.5

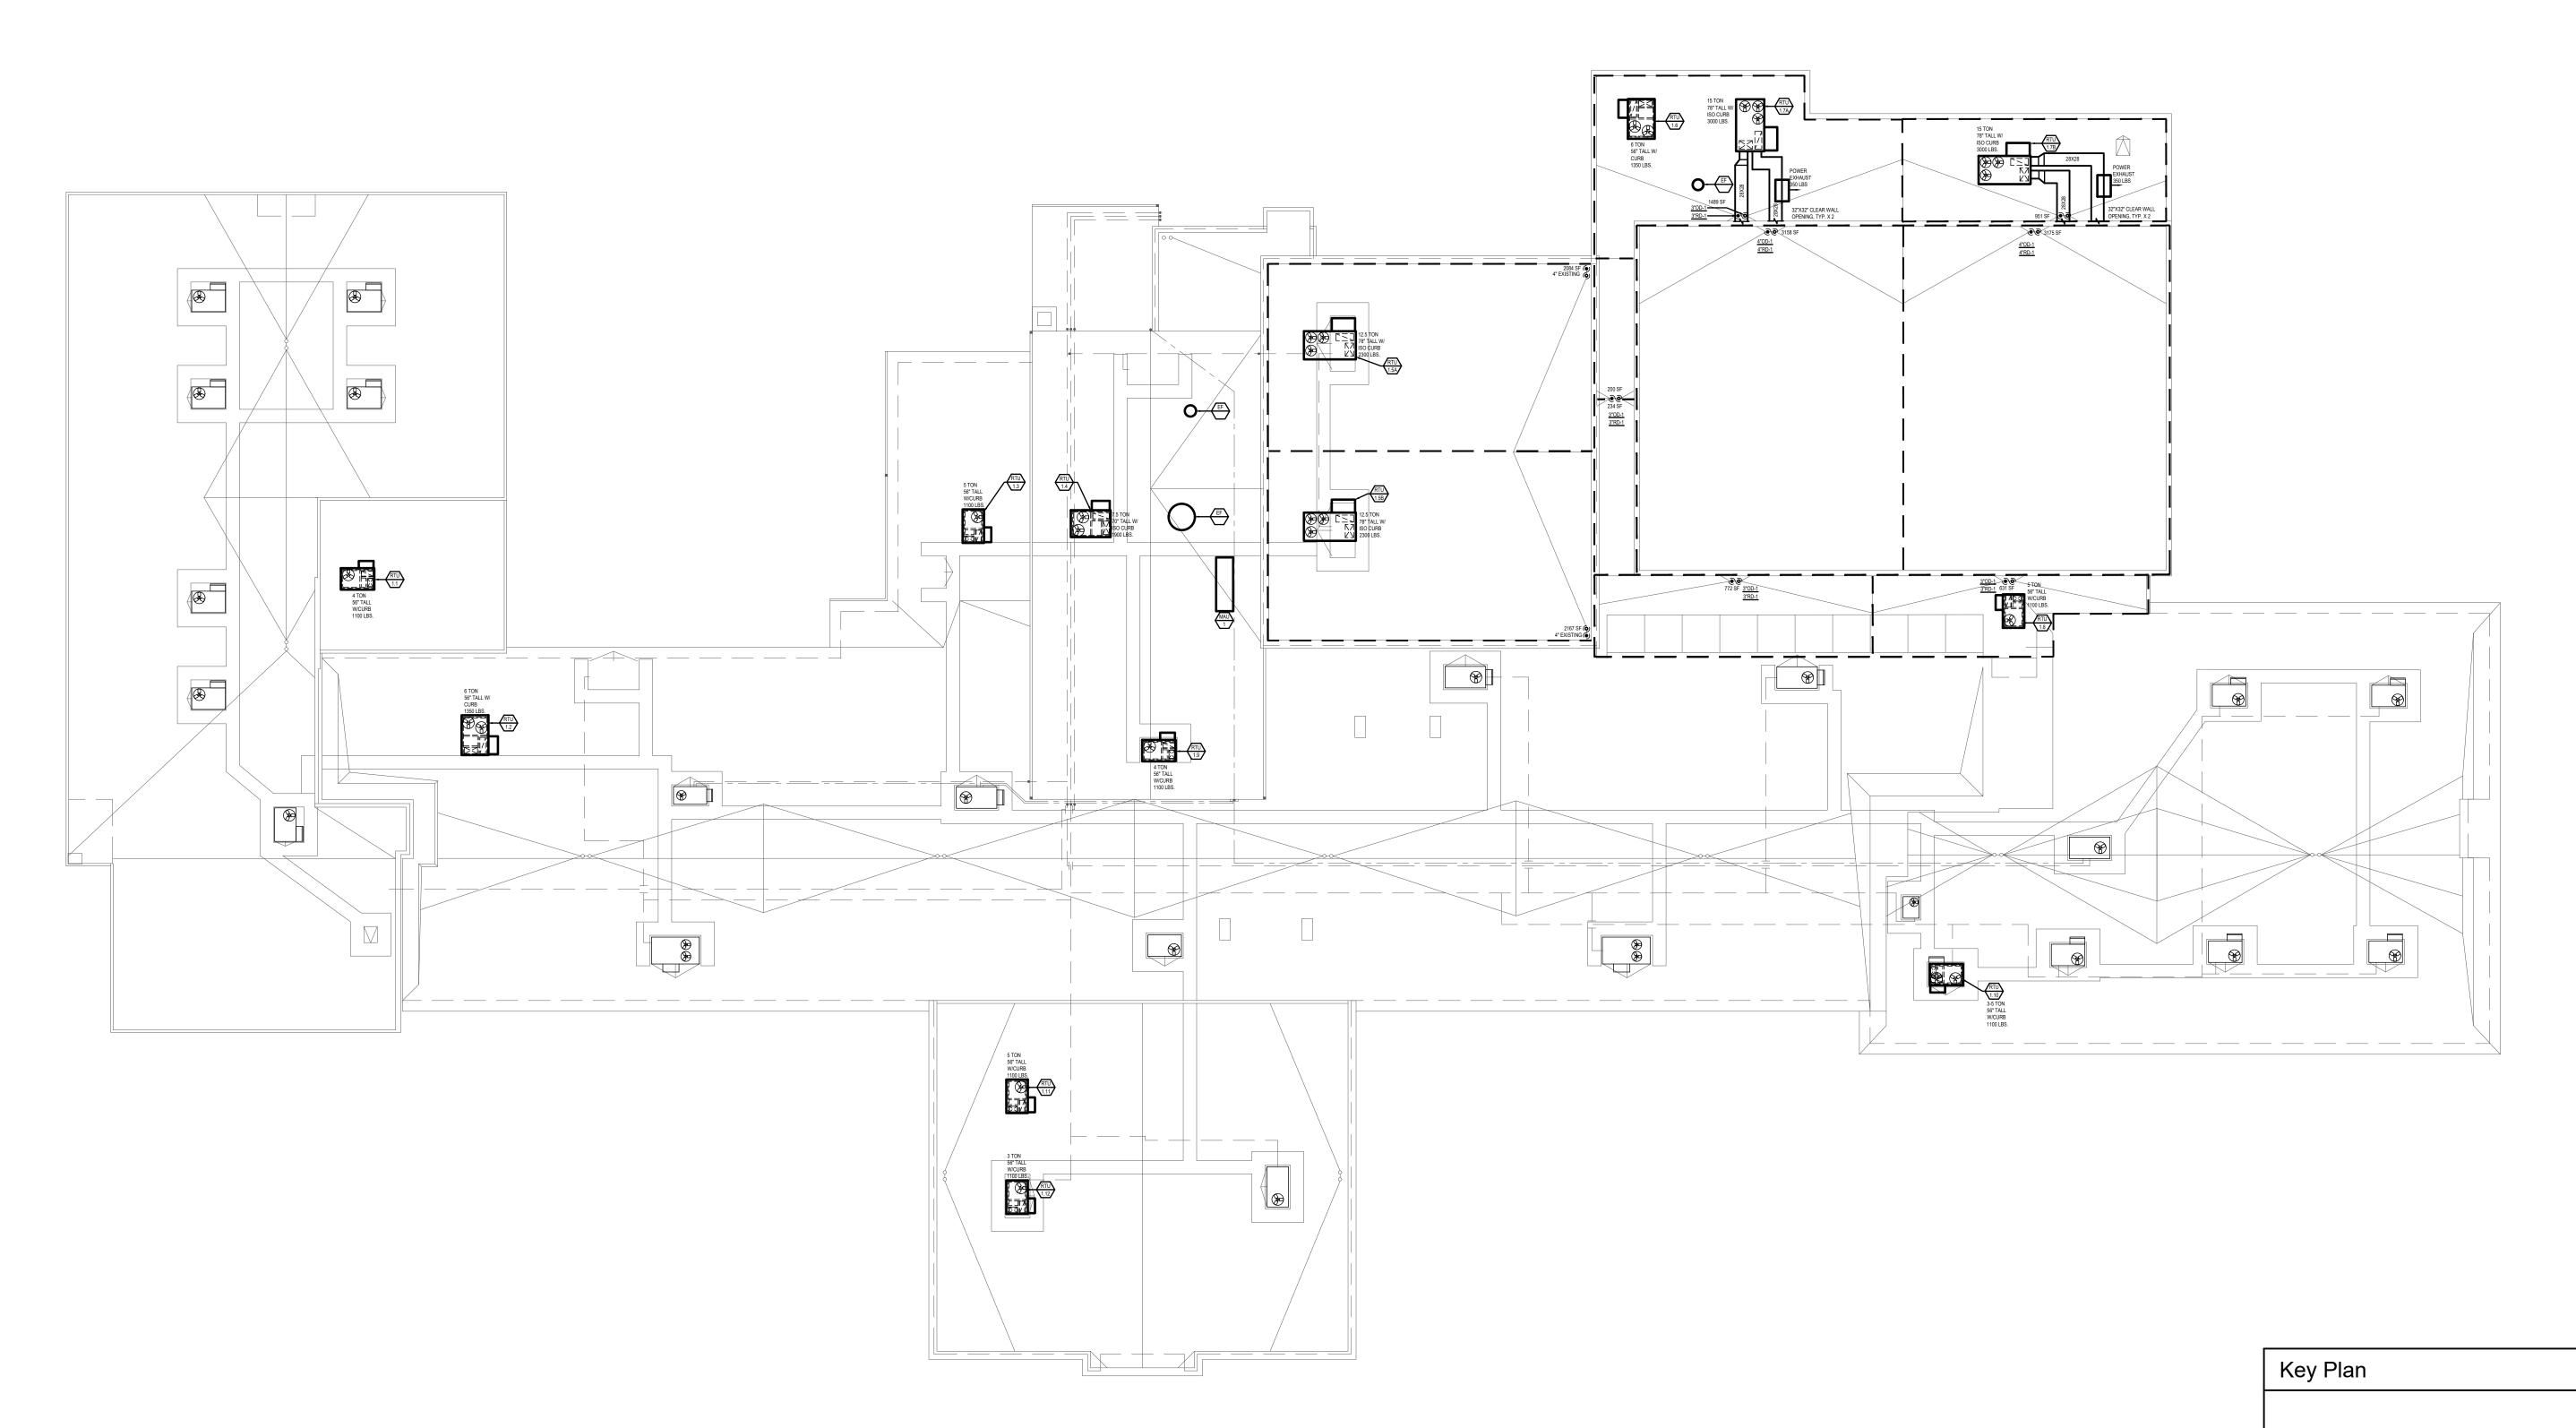

Overall Mechanical New Work Roof Plan



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Jefferson Elementary School Addition and Remodel

DATE: December 9, 2022 LKV PROJECT #: -REVISIONS:

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Area'A'


Area 'D'

Area'B'

Area 'E'

Design Development

DRAWING NO. M-4.0

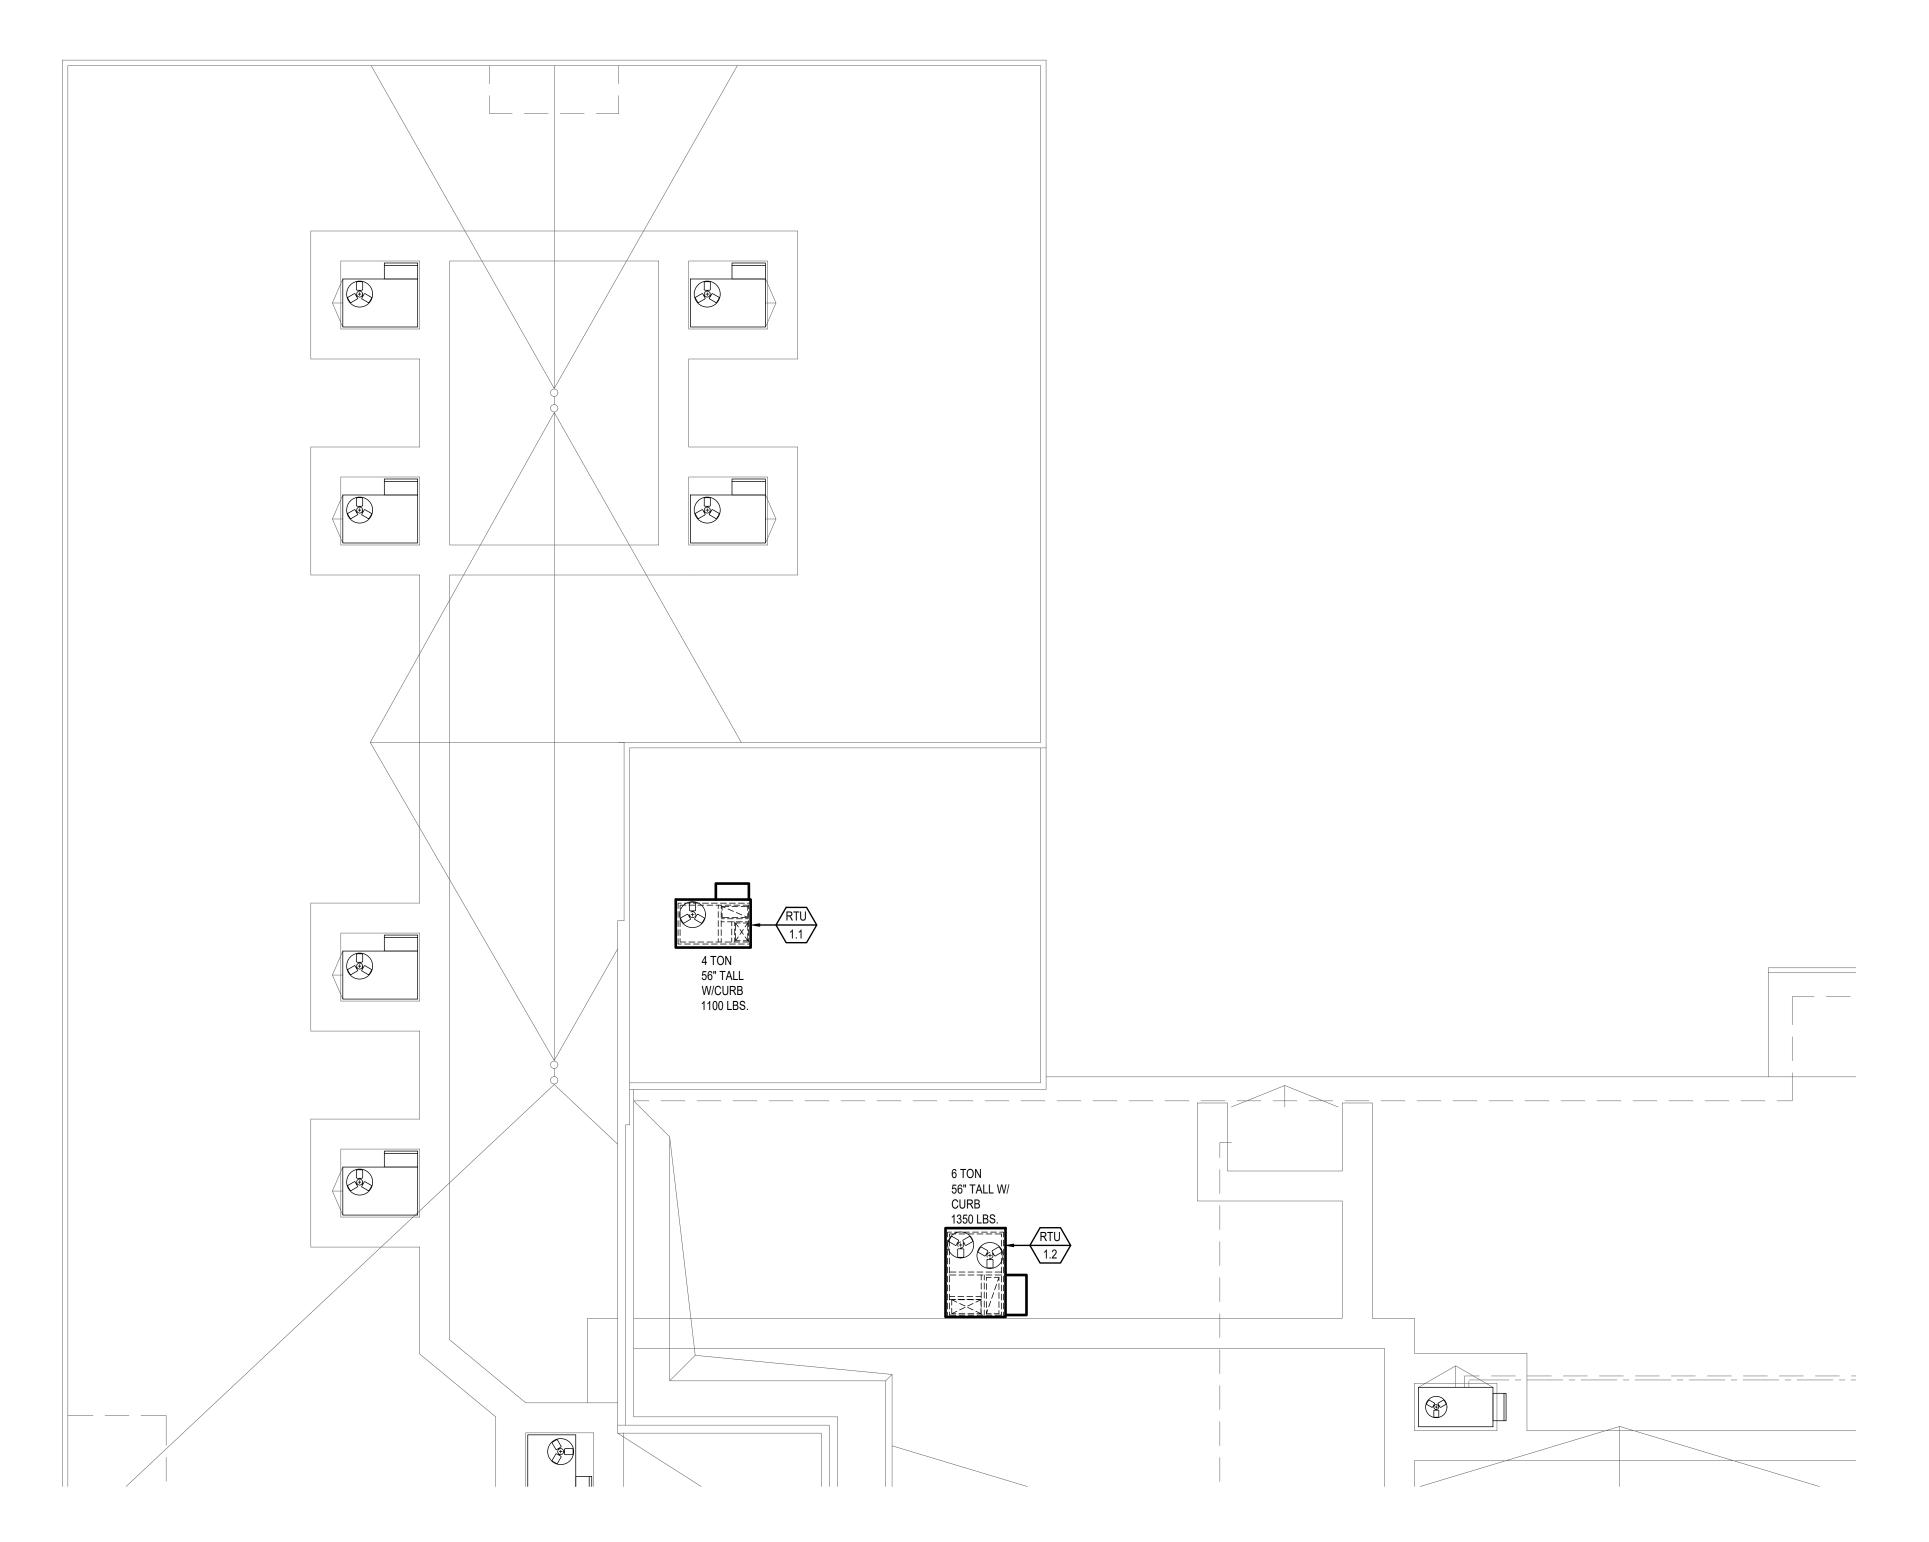

Mechanical New Work Roof Plan - Area 'A'

Scale: 1/8" = 1'-0"

# SYMBOL USED FOR NOTE CALLOUT.

1. KEYNOTES



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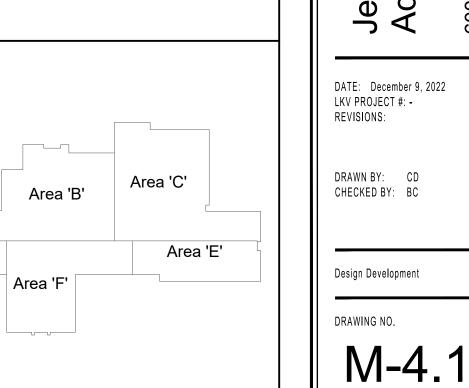


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OVER 40 YEARS OF EXCELLENCE
Project No. 22-104



Jefferson Elementary School Addition and Remodel




Key Plan

Area 'A'

Area 'D'

North Not to Scale

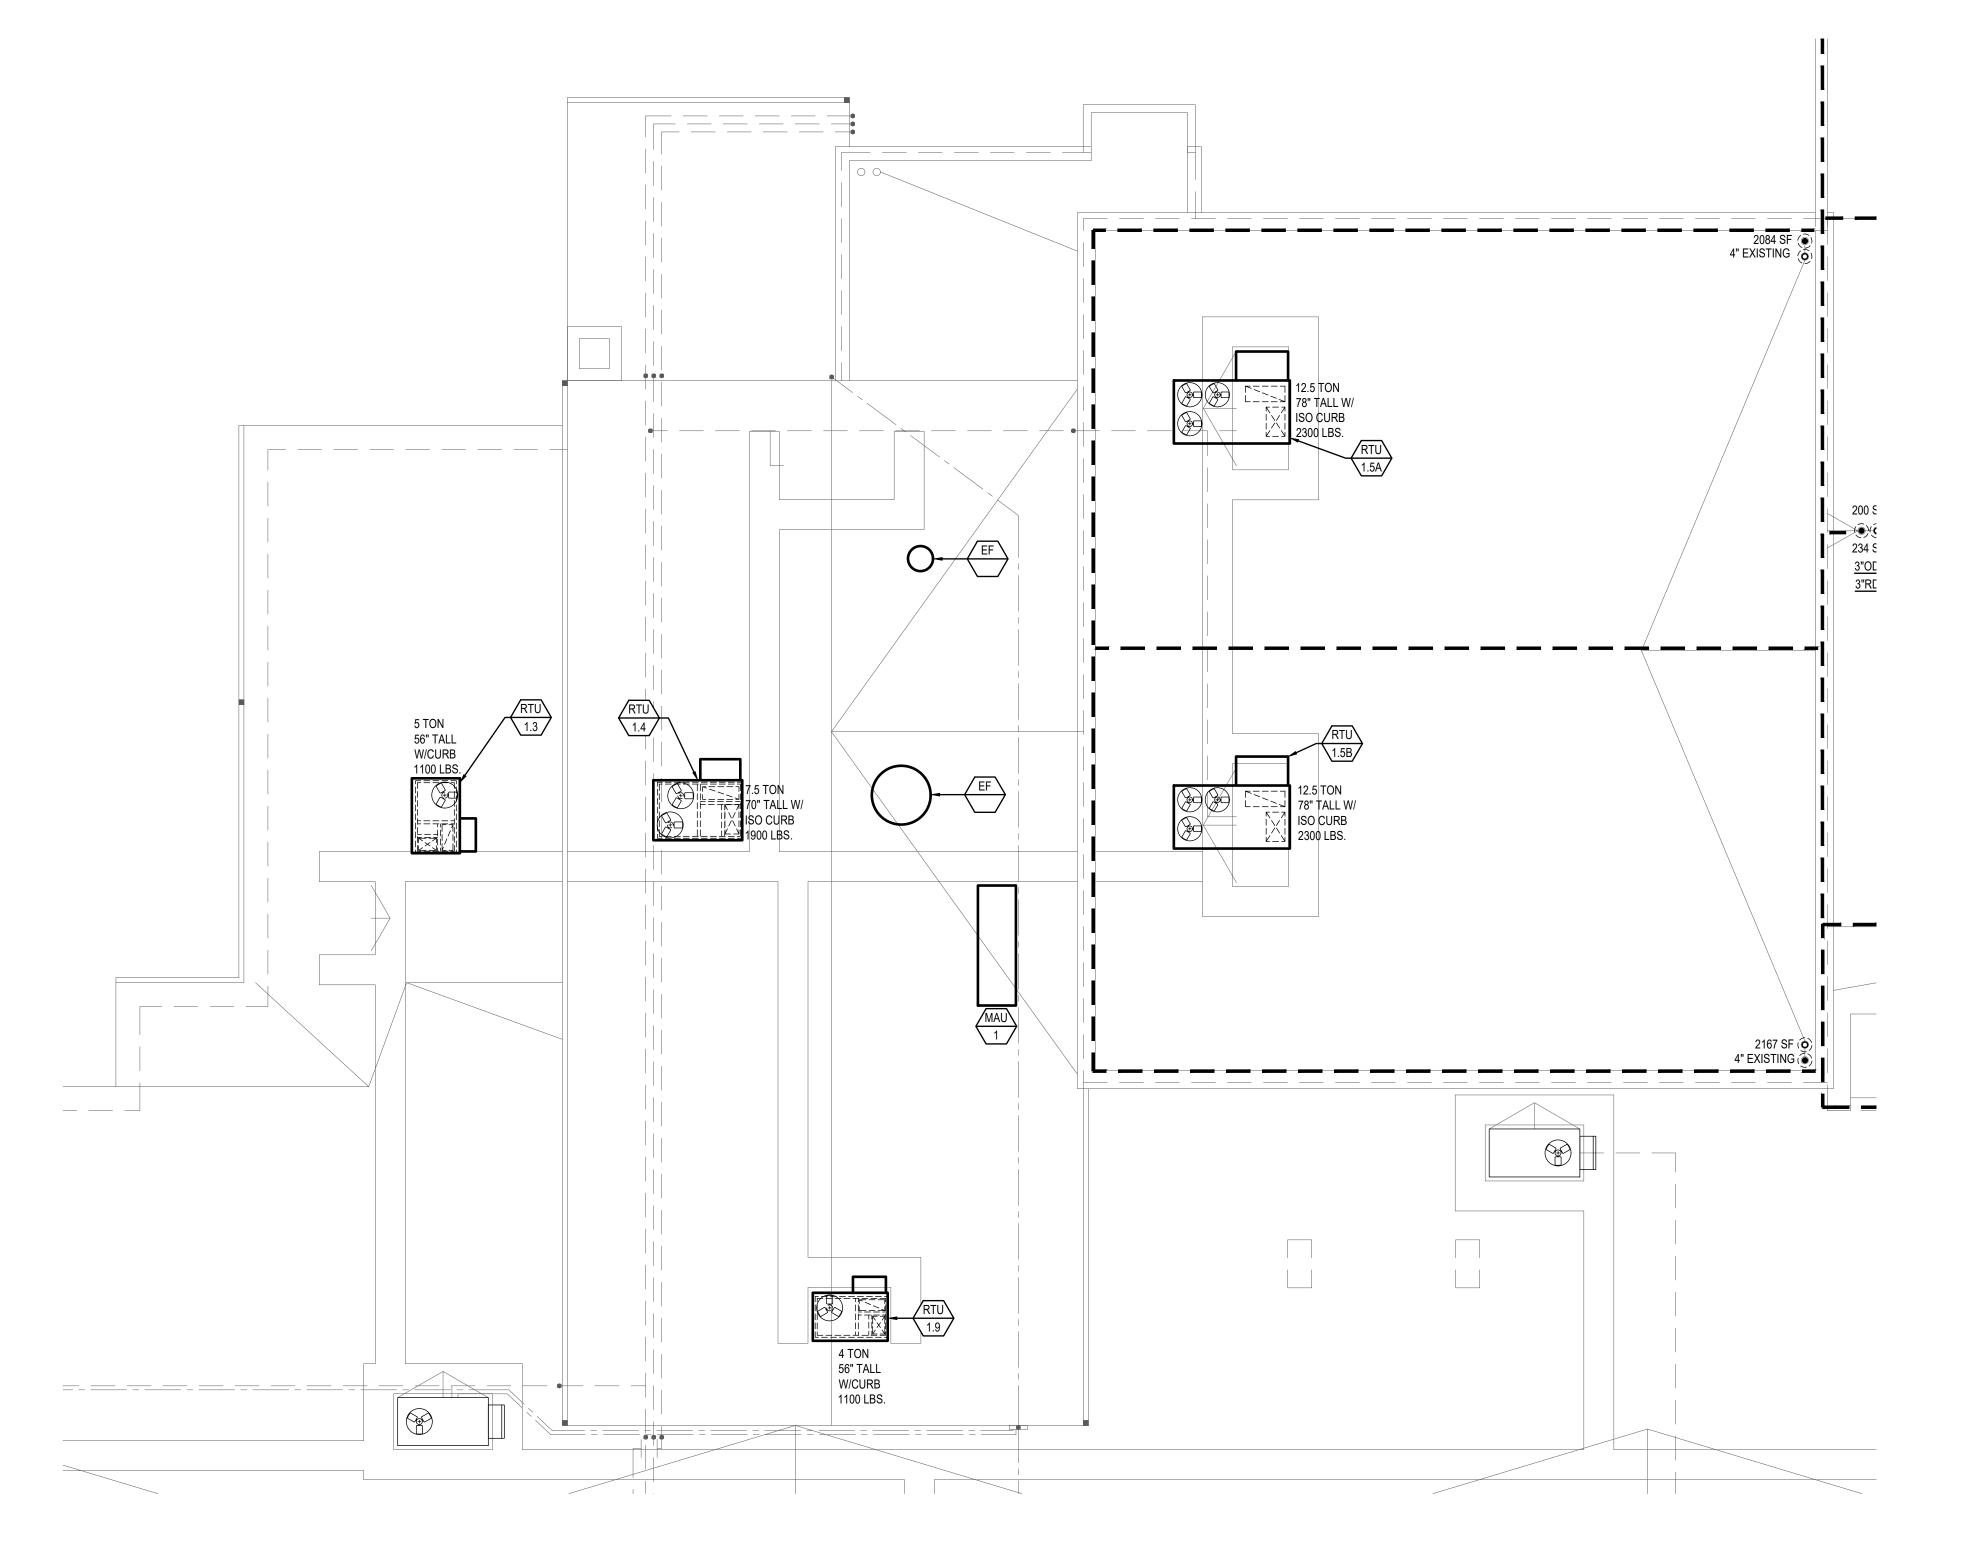

Mechanical New Work Roof Plan - Area 'B'

Scale: 1/8" = 1'-0"

# SYMBOL USED FOR NOTE CALLOUT.

1. KEYNOTES

Key Plan

Area 'A'

Area 'D'

North Not to Scale

Area 'B'

Area 'E'



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> Jefferson Elementary School Addition and Remodel

DATE: December 9, 2022 LKV PROJECT #: -REVISIONS:

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Design Development

M-4.2

Mechanical New Work Roof Plan - Area 'C'

#### **KEYED NOTES:**

# SYMBOL USED FOR NOTE CALLOUT.

1. KEYNOTES



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BOISE, IDAHO 83706

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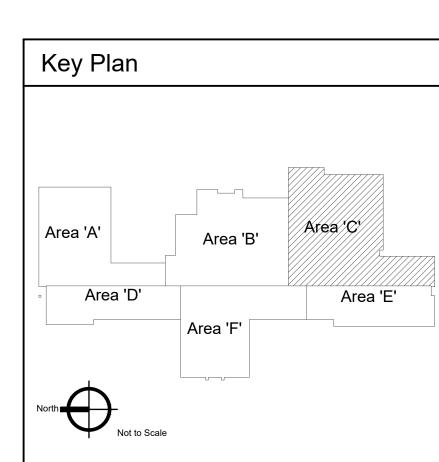


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OVER 40 YEARS OF EXCELLENCE
Project No. 22-104



Jefferson Elementary School Addition and Remodel




DATE: December 9, 2022 LKV PROJECT #: -REVISIONS:


> DRAWN BY: CD CHECKED BY: BC

> > Design Development

M-4.3

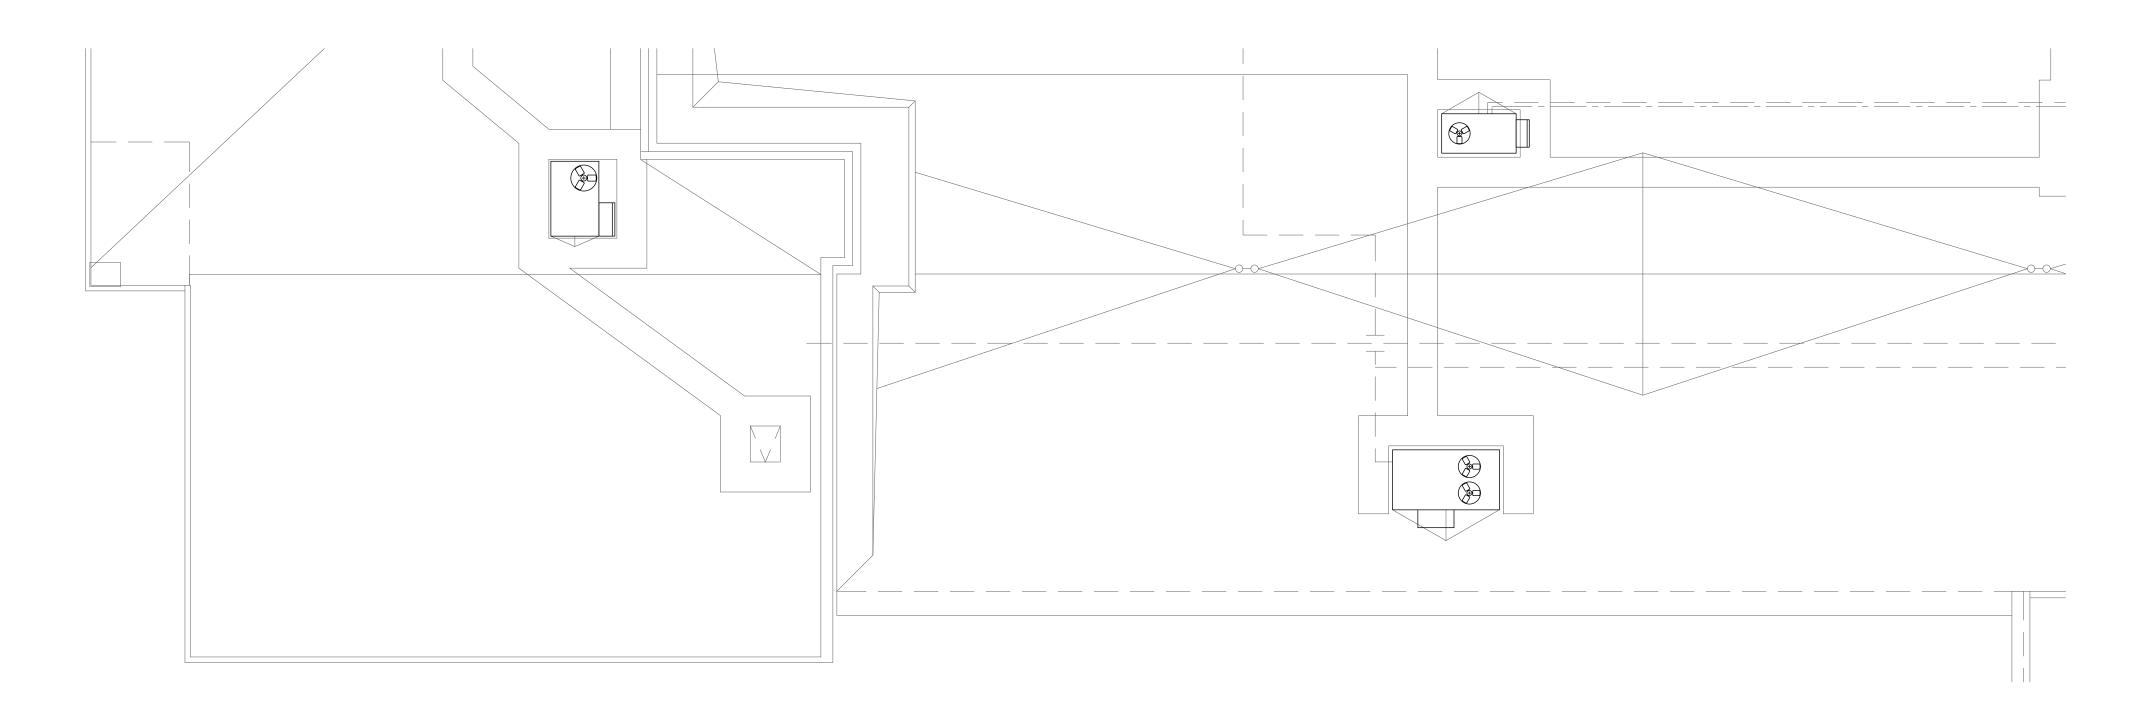

# Mechanical New Work Roof Plan - Area 'D' Scale: 1/8" = 1'-0"

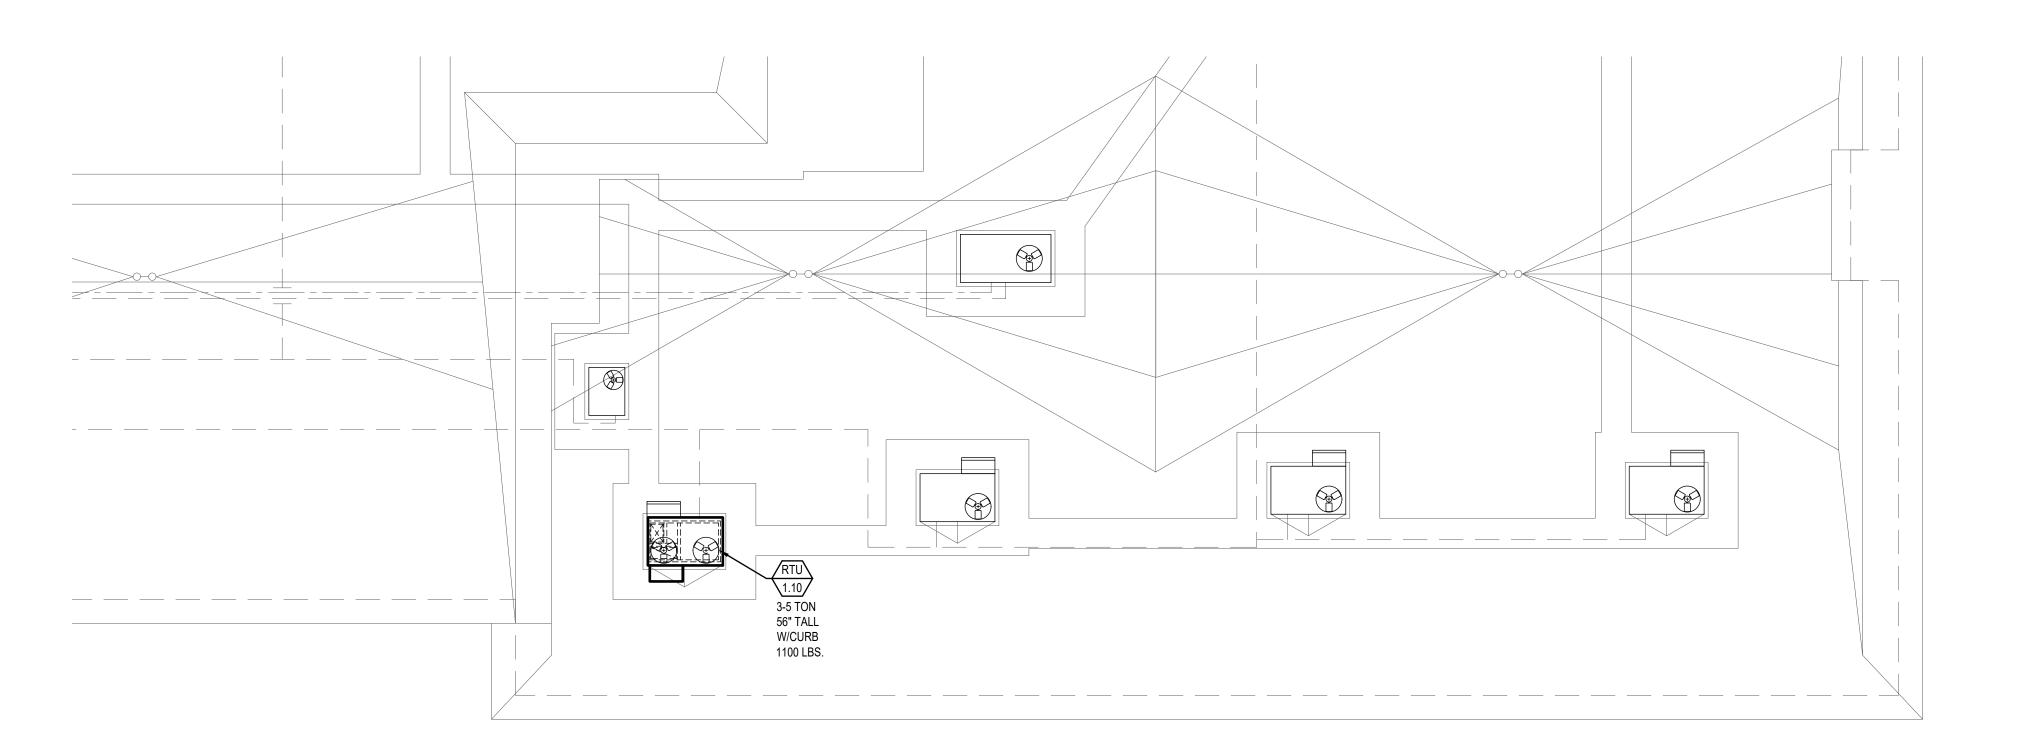



# **KEYED NOTES:**

# SYMBOL USED FOR NOTE CALLOUT.

1. KEYNOTES



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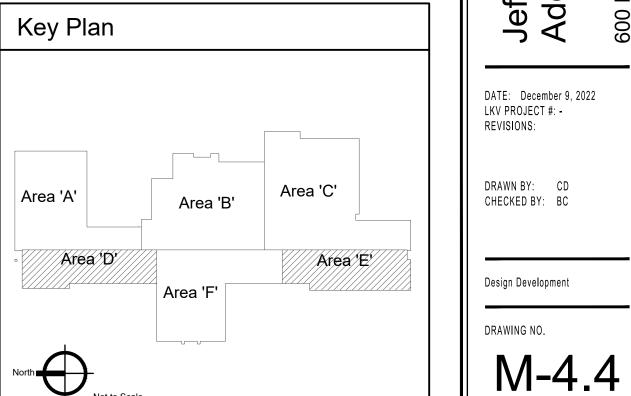


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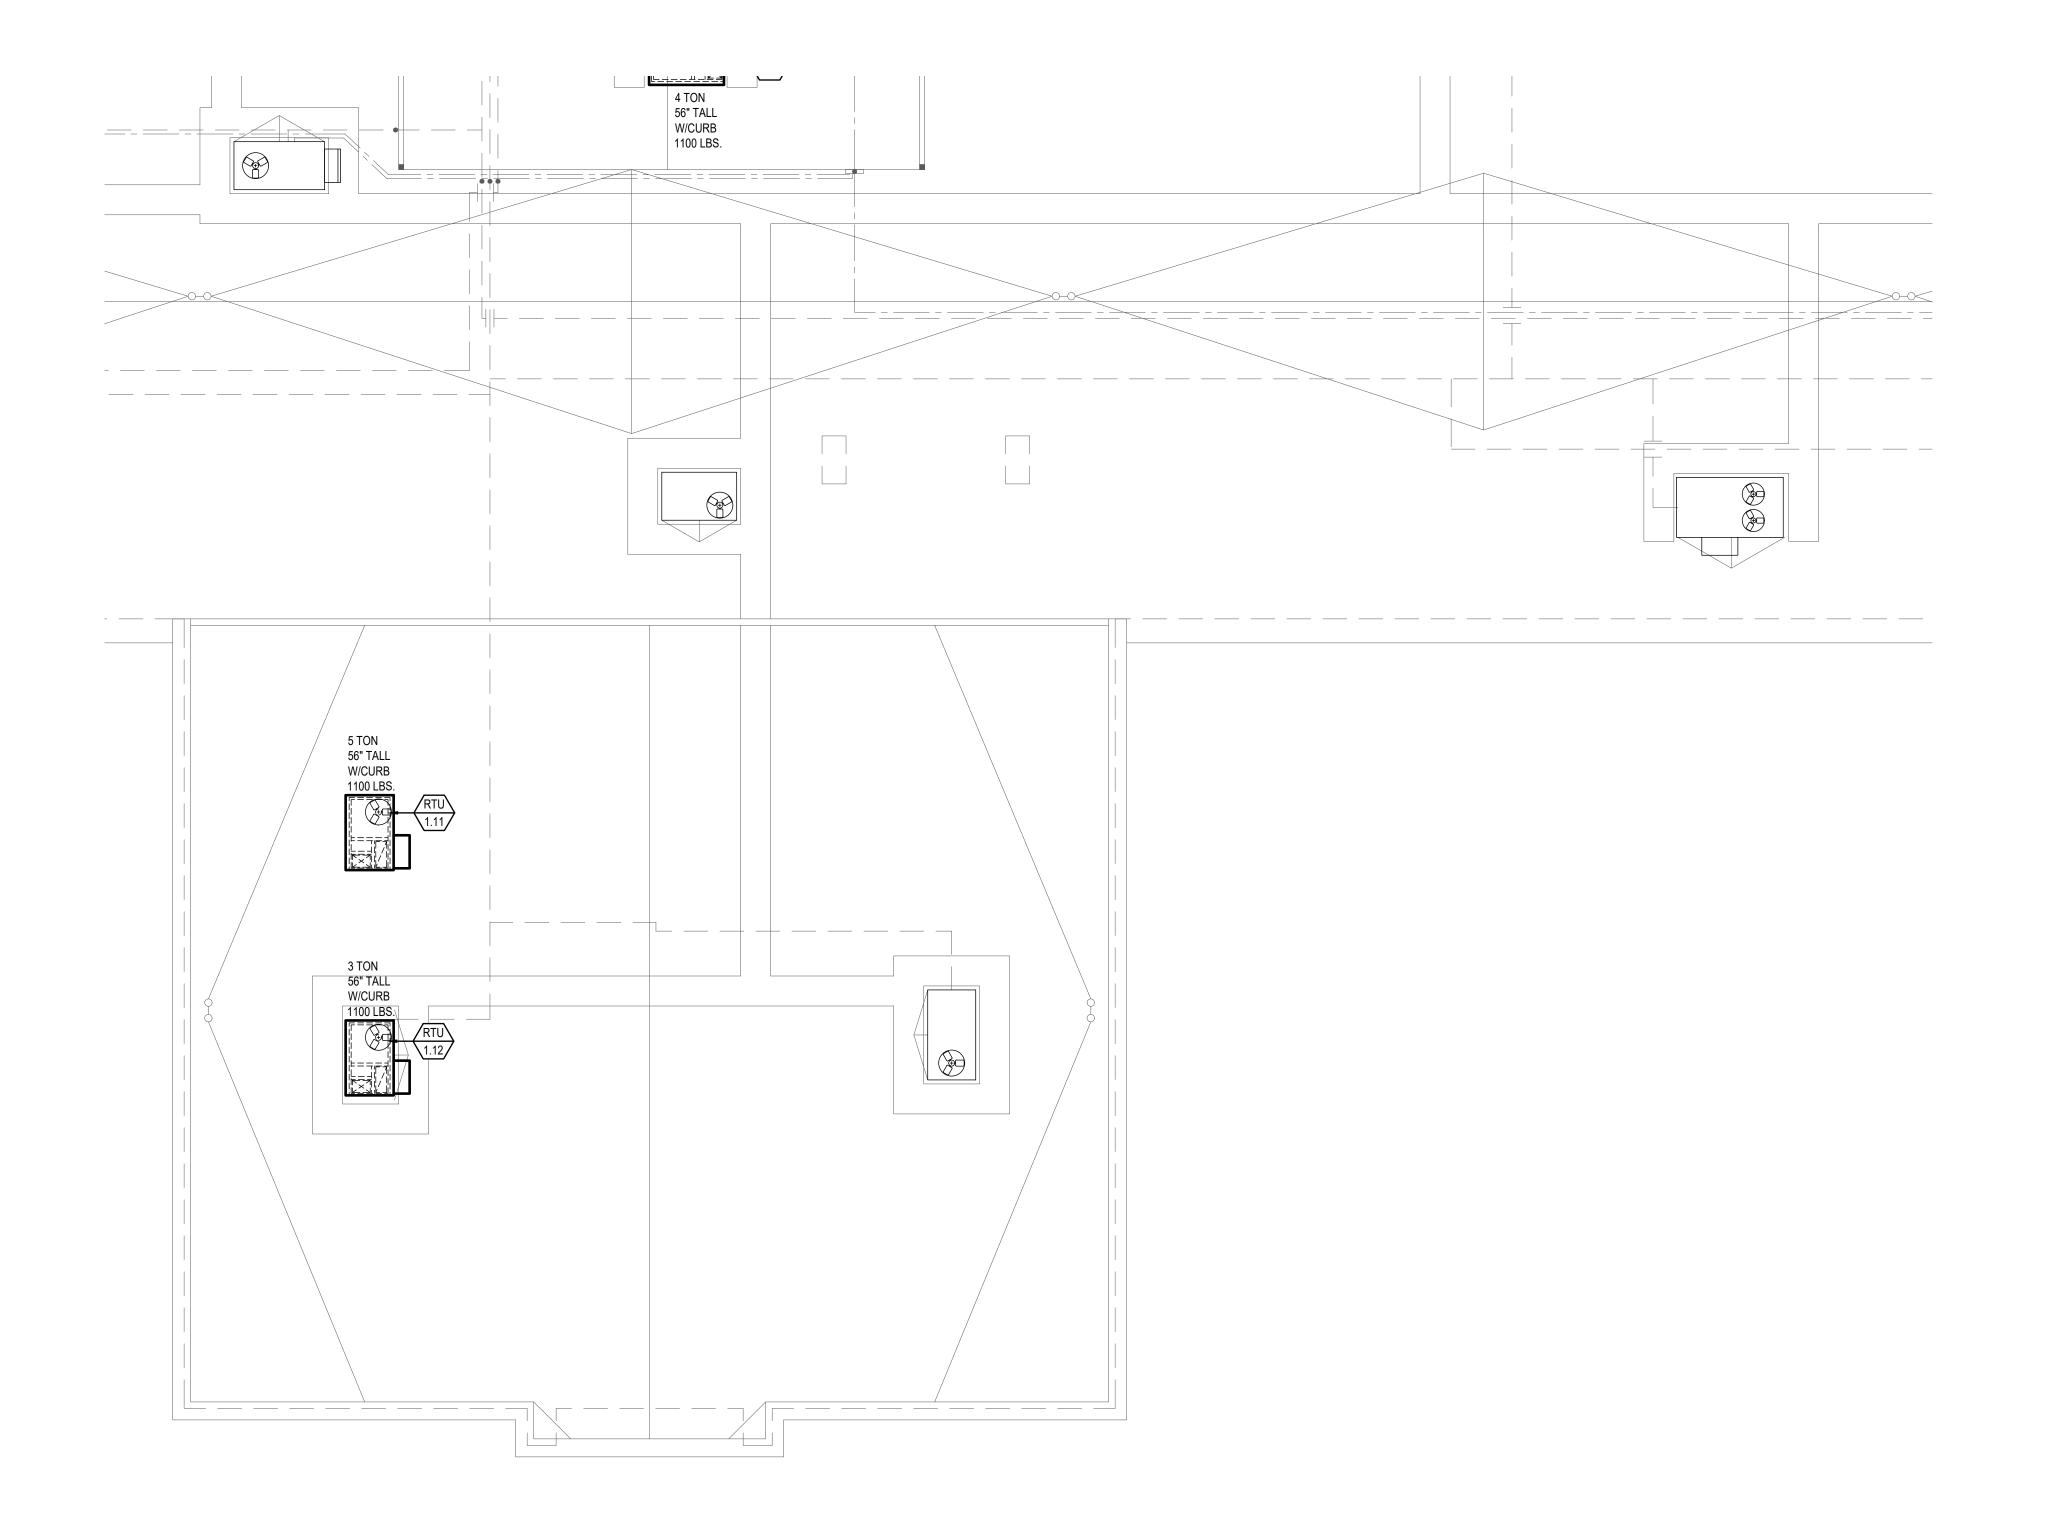
OVER 40 YEARS OF EXCELLENCE Project No. 22-104



Jefferson Elementary School Addition and Remodel



Area 'A'



Mechanical New Work Roof Plan - Area 'F'

# **KEYED NOTES:**

# SYMBOL USED FOR NOTE CALLOUT.

1. KEYNOTES



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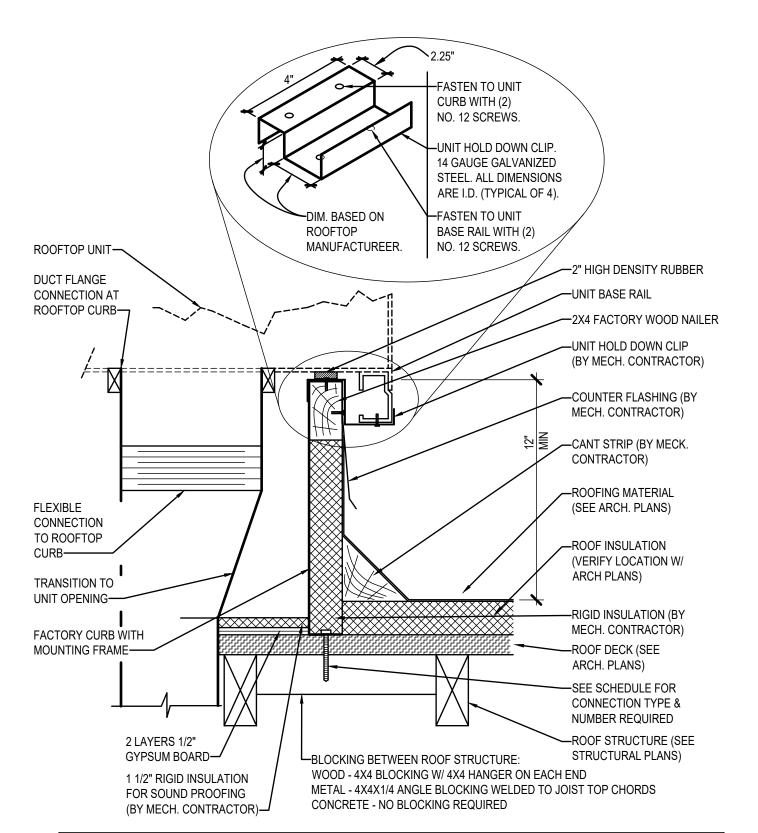
Project No. 22-104



Jefferson Elementary School Addition and Remodel

Key Plan DATE: December 9, 2022 LKV PROJECT #: -REVISIONS: DRAWN BY: CD CHECKED BY: BC Area 'B' Area 'D' Area 'E' Design Development DRAWING NO. North Not to Scale M-4.5


Area 'A'



CU	RB TC	) R00	F CONNE	CTION SCH	HEDULE
NOMINAL		TOTAL	NO. & TYP	E OF CONNECTION (EQUALL	Y SPACED)
ROOFTOP UNIT	MAX. WEIGHTS	LATERAL FORCE		ROOF STRUCTURE TYPE	
CAPACITY	WLIGITIS	(Fp)	METAL	WOOD	CONCRETE
3-6 TONS	750 LBS	810 LBS	(4) 1/2" LAG BOLT	(4) 1/2" LAG BOLT	(4) 3/8" EXPANSION BOLT

COMPLIES WITH THE INTERNATIONAL BUILDING CODE




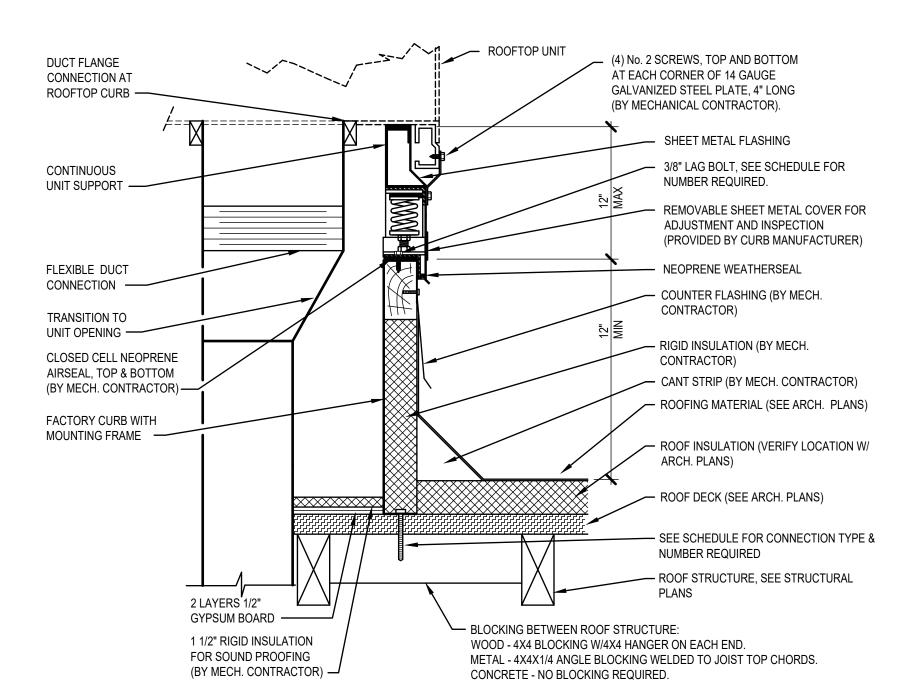


(	CURB TO ROOF CONNECTION SCHEDULE											
NOMINAL		TOTAL	NO.	& TYPE OF CONNECTION (EQ	UALLY SPACED)							
ROOFTOP UNIT WEIGHTS FORCE (Fp)												
CAPACITY FORCE (Fp) METAL WOOD CONCRETE												
7-8 TONS	1050 LBS	1135 LBS	(6) 1/2" LAG BOLT	(6) 1/2" LAG BOLT	(6) 3/8" EXPANSION BOLT							
10-12 TONS	1300 LBS	1405 LBS	(8) 1/2" LAG BOLT	(8) 1/2" LAG BOLT	(8) 3/8" EXPANSION BOLT							
15-18 TONS	2500 LBS	2700 LBS	(14) 1/2" LAG BOLT	(14) 1/2" LAG BOLT	(14) 3/8" EXPANSION BOLT							
20-25 TONS 2800 LBS 3025 LBS (16) 1/2" LAG BOLT (16) 1/2" LAG BOLT (16) 3/8" EXPANSION BOLT												
COMPLIES WITH THE INTERNATIONAL BUILDING CODE												

MANUFACTURER SHALL PROVIDE CALCULATIONS FOR THE CURB MOUNTED SPRING RAIL SHOWING COMPLIANCE WITH THE INTERNATIONAL BUILDING CODE (LATEST ADOPTED EDITION).

# ROOFTOP UNIT - CURB MOUNTED SPRING RAIL DETAIL NOT TO SCALE

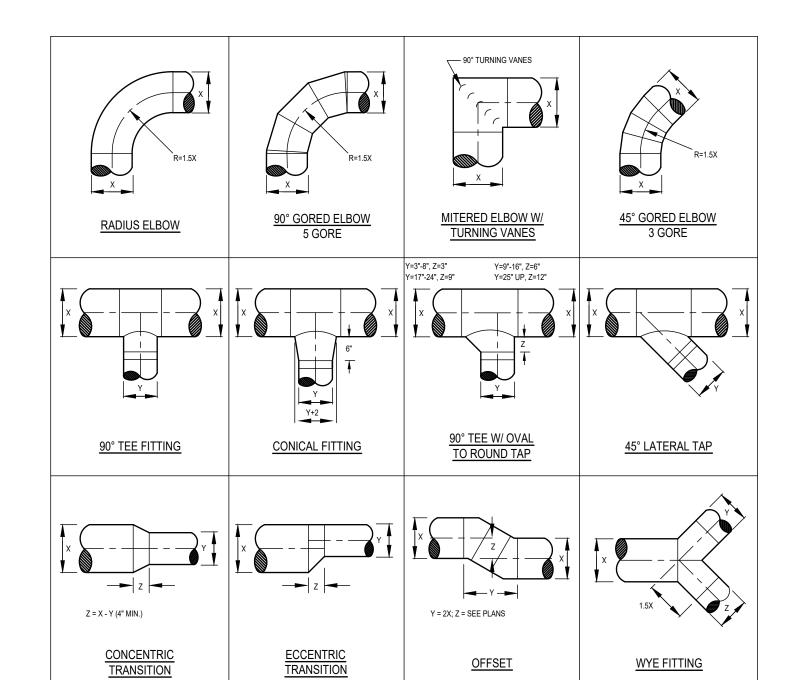


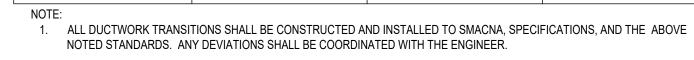


<u>OFFSET</u>

WYE FITTING



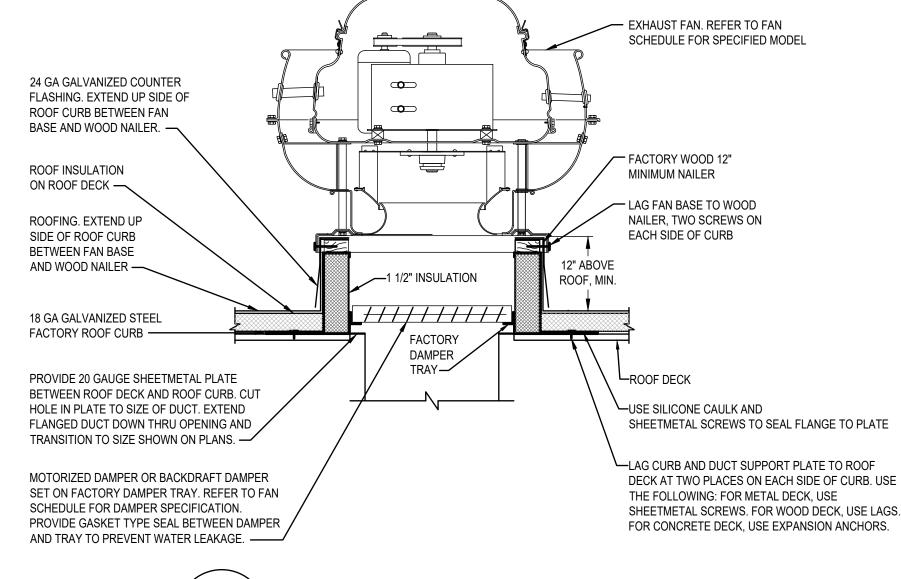



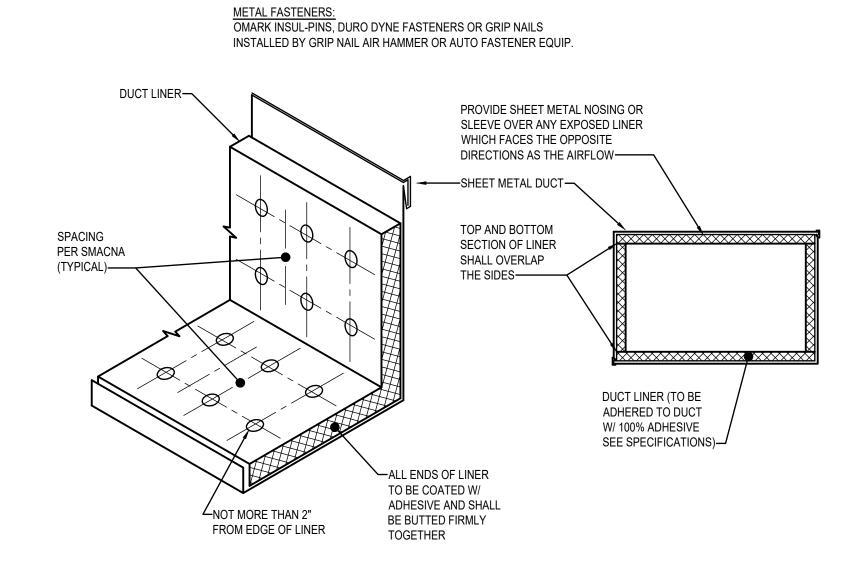





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School Elementary Sand Remodel and Jefferson Addition a


LKV PROJECT #: -REVISIONS:


DATE: December 9, 2022

DRAWN BY: CD CHECKED BY: BC


Design Development


DRAWING NO.

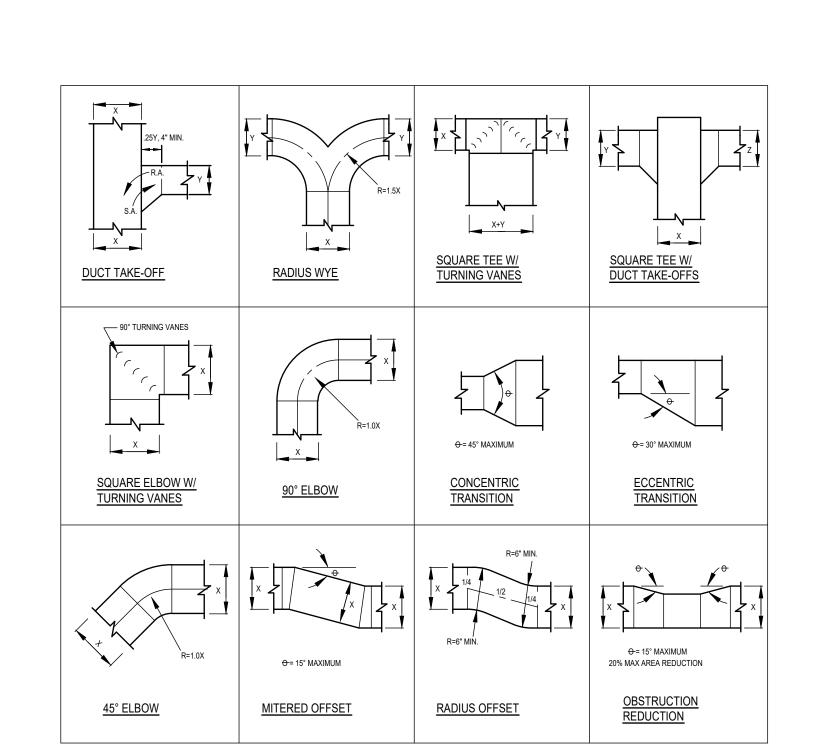

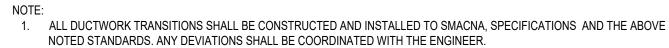





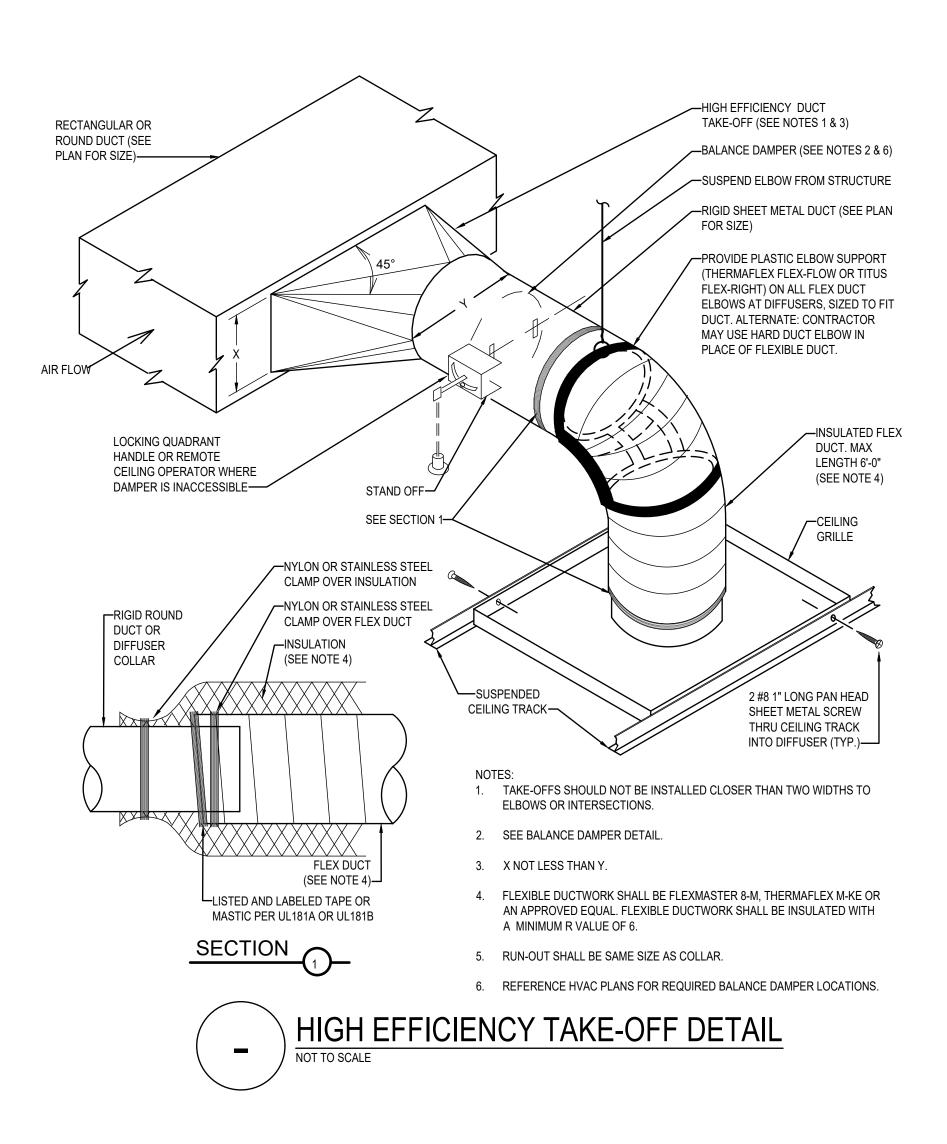

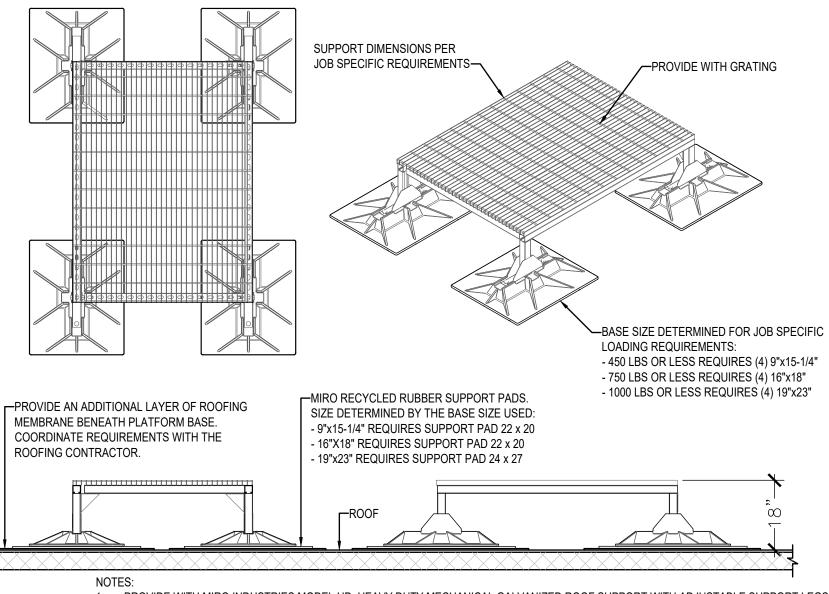

- 1. PROVIDE WITH MIRO INDUSTRIES MODEL HD, HEAVY DUTY MECHANICAL GALVANIZED ROOF SUPPORT WITH ADJUSTABLE SUPPORT LEGS.
- 2. SUPPORT SHALL EXTEND A MINIMUM OF 6" BEYOND EQUIPMENT IN EACH DIRECTION.
- 3. BOLT EQUIPMENT TO MECHANICAL SUPPORT, A MINIMUM OF (4) LOCATIONS.
- 4. APPROVED ALTERNATE MANUFACTURERS: UNISTRUT AND ROOF-PRO.

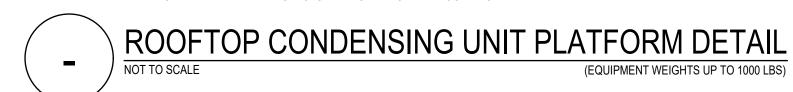

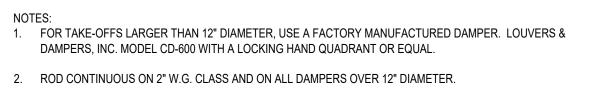


3. BLADE 22 GAGE MIN., BUT NOT LESS THAN TWO GAGES MORE THAN THE DUCT GAGE.

4. PROVIDE REMOTE CEILING OPERATOR WHERE DAMPER IS INACCESSIBLE.


5. FOR DUCTS OVER 12" HIGH USE MULTIPLE BLADE DAMPERS (SEE FIG. C).

6. ALTERNATE MANUFACTURERS INCLUDE: AMERICAN WARMING, SAFE-AIR/DOWCO, J&J, LOUVERS & DAMPERS, RUSKIN, NAILOR, ARROW UNITED, POTTORFF, & CESCO.

7. PROVIDE STAND-OFF FOR DAMPER ARMS LOCATED W/EXTERNAL INSULATION.

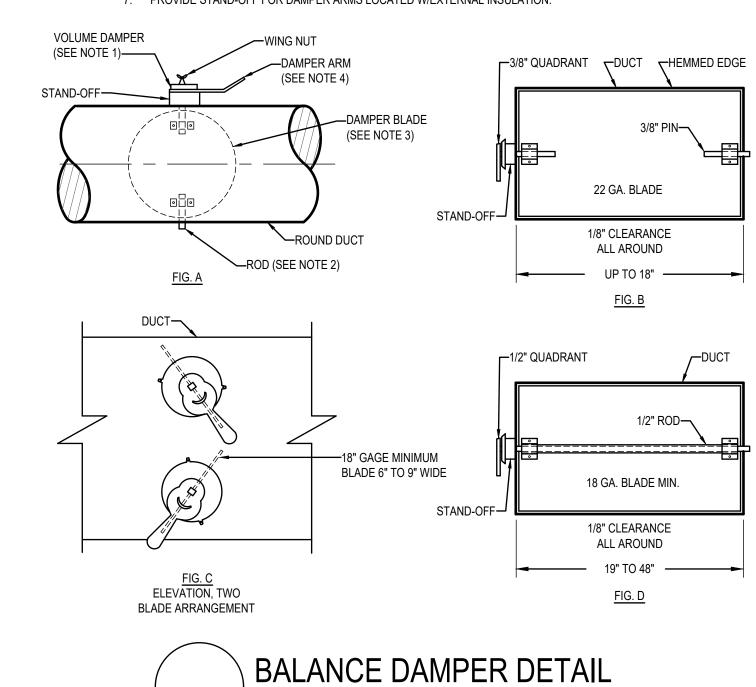

NOT TO SCALE

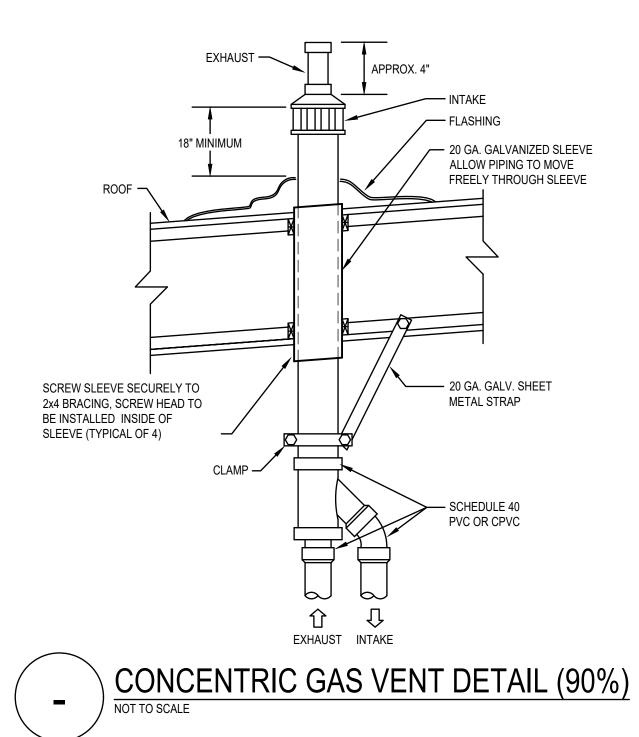



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Jefferson Elementary School Addition and Remodel

DATE: December 9, 2022 LKV PROJECT #: -REVISIONS:

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Design Development

DRAWING NO.

M-6.1

			\			P	4CK	AGE	ED A	AIR (	CON	1DI_	ΓΙΟΙ	VIN	G S	CHE	EDU	LE					
SYMBOL	AREA SERVED	NOM.		SUPPI	LY FAN		l	LING CAPA A, 80°EDB, 6			EATING ACITY	RTU	J ELECTRI	ICAL	ELEC	TRICAL PO	OWER EXH	HAUST	OSA	MIN. SEER /	OPER. WEIGHT	MANUFACTURER AND MODEL	REMARKS
OTWIDGE	ANEXIOENVED	TONS	CFM	ESP	BRAKE BHP	DRIVE	STAGES	TOTAL MBH	SENS. MBH	INPUT MBH	OUTPUT MBH	MCA	MOCP	V/Ø	HP	MCA	MOCP	V/Ø	CFM	EER	(LBS)	WANGI ACTORER AND MODEL	TALIW II AAO
<u>RTU-1.1</u>	CLASSROOM 120	4	1600	.50	.72	DIRECT ECM	1	42.8	41.3	120.0 / 150.0	96.0 / 120.0	24.0	30	208/3	0.5	2.9	5.2	208/3	320	14.0	1100	CARRIER 48FC-05 STANDARD EFFICIENCY	1,2,3,5,6,7,8
<u>RTU-1.2</u>	CLASSES 132, 134 & 136	5	2000	.50	1.06	DIRECT ECM	1	53.7	53.7	120.0 / 150.0	96.0 / 120.0	29.0	40	208/3	0.5	2.9	5.2	208/3	320	14.0	1100	CARRIER 48FC-06 STANDARD EFFICIENCY	1,2,3,5,6,7,8
<u>RTU-1.3</u>	TEACHER LOUNGE	5	2000	.50	1.06	DIRECT ECM	1	53.7	53.7	120.0 / 150.0	96.0 / 120.0	29.0	40	208/3	0.5	2.9	5.2	208/3	320	14.0	1100	CARRIER 48FC-06 STANDARD EFFICIENCY	1,2,3,5,6,7,8
<u>RTU-1.4</u>	KITCHEN	7.5	3000	.50	2.4	DIRECT ECM	2	81.7	78.4	120.0 / 180.0	98.0 / 148.0	39.0	50	208/3	N/A	N/A	N/A	208/3	320	11.2 EER	1900	CARRIER 48FC-08 STANDARD EFFICIENCY	1,2,3,5,6,7,8
<u>RTU-1.5A</u>	CAFETERIA	12.5	5000	.50	3.0	DIRECT ECM	2	136.2	128.5	180.0/ 224.0	146.0/ 181.0	63.0	80	208/3	2	11.9	21.4	208/3	320	10.2 EER	2300	CARRIER 48FC-14 STANDARD EFFICIENCY	1,2,3,5,6,7,8
<u>RTU-1.5B</u>	CAFETERIA	12.5	5000	.50	3.0	DIRECT ECM	2	136.2	128.5	180.0/ 224.0	146.0/ 181.0	63.0	80	208/3	2	11.9	21.4	208/3	320	10.2 EER	2300	CARRIER 48FC-14 STANDARD EFFICIENCY	1,2,3,5,6,7,8
<u>RTU-1.6</u>	STAGE	6	2400	.50	1.31	DIRECT ECM	2	66.9	66.5	120.0 / 150.0	96.0 / 120.0	33.0	50	208/3	0.5	2.9	5.2	208/3	320	11.2 EER	1350	CARRIER 48FC-07 STANDARD EFFICIENCY	1,2,3,5,6,7,8
RTU-1.7A	GYM	15	6000	.50	3	DIRECT ECM	2	166.7	163.8	280.0 / 350.0	224.0 / 284.0	67.0	80	208/3	3	11.5	20.7	208/3	800	10.8 EER	3000	CARRIER 48FC-16 STANDARD EFFICIENCY HORIZONTAL DISCHARGE	1,2,4,5,6,7,8
RTU-1.7B	GYM	15	6000	.50	3	DIRECT ECM	2	166.7	63.8	280.0 / 350.0	224.0 / 284.0	67.0	80	208/3	3	11.5	20.7	208/3	800	10.8 EER	3000	CARRIER 48FC-16 STANDARD EFFICIENCY HORIZONTAL DISCHARGE	1,2,4,5,6,7,8
<u>RTU-1.8</u>	GYM FOYER	5	2000	.50	1.06	DIRECT ECM	1	53.7	53.7	120.0 / 150.0	96.0 / 120.0	29.0	40	208/3	0.5	2.9	5.2	208/3	320	14.0	1100	CARRIER 48FC-06 STANDARD EFFICIENCY	1,2,3,5,6,7,8
<u>RTU-1.9</u>	MULTIPURPOSE CLASS	4	1600	.50	.72	DIRECT ECM	1	42.8	41.3	120.0 / 150.0	96.0 / 120.0	24.0	30	208/3	0.5	2.9	5.2	208/3	320	14.0	1100	CARRIER 48FC-05 STANDARD EFFICIENCY	1,2,3,5,6,7,8
RTU-1.10	PREP ROOM	3	1200	.50	.44	DIRECT ECM	1	30.9	29.9	82.0 / 110.0	65.0 / 93.0	19.0	25	208/3	0.5	2.9	5.2	208/3	320	14.0	1100	CARRIER 48FC-04 STANDARD EFFICIENCY	1,2,3,5,6,7,8
RTU-1.11	COMPUTER LAB	5	2000	.50	1.06	DIRECT ECM	1	53.7	53.7	120.0 / 150.0	96.0 / 120.0	29.0	40	208/3	0.5	2.9	5.2	208/3	320	14.0	1100	CARRIER 48FC-06 STANDARD EFFICIENCY	1,2,3,5,6,7,8
RTU-1.12	ADMIN	3	1200	.50	.44	DIRECT ECM	1	30.9	29.9	82.0 / 110.0	65.0 / 93.0	19.0	25	208/3	0.5	2.9	5.2	208/3	320	14.0	1100	CARRIER 48FC-04 STANDARD EFFICIENCY	1,2,3,5,6,7,8

#### DEMADE

- 1. APPROVED ALTERNATE MANUFACTURERS: BRYANT, TRANE, AAON, LENNOX, AND YORK.
- 2. PROVIDE UNIT WITH SEVEN-DAY PROGRAMMABLE AUTO-CHANGEOVER WITH 5 DEGREE DEADBAND, ADAPTIVE INTELLIGENT AUTOMATIC START/ CONTROL, 3 STAGE HEAT, 2 STAGE COOLING THERMOSTAT HONEYWELL VISIONPRO MODEL TH8321R1001 WITH ECONOMIZER FAULT DETECTION. THERMOSTAT SHALL BE POWERED BY A 24VAC WIRE CONNECTION.
- 3. PROVIDE UNIT WITH MANUFACTURER'S ROOF CURB (SEE DETAIL FOR SEISMIC RESTRAINTS), HAIL GUARDS, LOW AMBIENT CONTROLS (TO 0°F), FLUE EXTENDER, HIGH ALTITUDE KIT, THRU-THE-BOTTOM OF CURB ELECTRICAL CONNECTION KIT, HINGED ACCESS PANELS. MICROMETL GEAR DRIVEN INTEGRATED DRY BULB ECONOMIZER WITH BELIMO LOGIC ACTUATORS, MICROMETL CENTRIFUGAL POWER EXHAUST (100% RELIEF) WITH WIRING HARNESS AND JADE CONTROLLER (STANDALONE TSTAT) ELECTRICAL CONTRACTOR TO PROVIDE THE POWER CONNECTION BETWEEN RTU AND THE POWER EXHAUST AND PROVIDE FUSED DISCONNECT AS REQUIRED.
- 5. PROVIDE UNIT WITH MICROMETL WELDED SPRING ISOLATION CURB (SEE DETAIL FOR SEISMIC RESTRAINTS), PROVIDE MANUFACTURER'S FLUE EXTENDER, HAIL GUARDS, HIGH ALTITUDE KIT, HINGED ACCESS PANELS, MICROMETL GEAR DRIVEN INTEGRATED DRY BULB ECONOMIZER WITH BELIMO LOGIC ACTUATORS, MICROMETL CENTRIFUGAL POWER EXHAUST (100% RELIEF) WITH WIRING HARNESS AND JADE CONTROLLER (USE JADE ONLY FOR STANDALONE TSTAT). ELECTRICAL CONTRACTOR TO PROVIDE THE POWER CONNECTION BETWEEN RTU AND THE POWER EXHAUST AND PROVIDE FUSED DISCONNECT AS REQUIRED.

#### E

- 6. PROVIDE UNIT WITH MICROMETL WELDED SPRING ISOLATION CURB (SEE DETAIL FOR SEISMIC RESTRAINTS), PROVIDE UNIT WITH MANUFACTURERS FLUE EXTENDER, HAIL GUARDS, HIGH ALTITUDE KIT, HINGED ACCESS PANELS, MICROMETL GEAR DRIVEN INTEGRATED DRY BULB ECONOMIZER WITH BELIMO LOGIC ACTUATORS AND AUX END SWITCH, MICROMETL MODULATING POWER EXHAUST WITH VARIABLE SPEED MOTOR CONTROLLER (100% RELIEF) WIRING HARNESS AND JADE CONTROLLER (USE JADE ONLY FOR STANDALONE TSTAT), PRESSURE SENSOR SET TO .02 POSITIVE PRESSURE. ELECTRICAL CONTRACTOR TO PROVIDE THE POWER CONNECTION BETWEEN RTU AND THE POWER EXHAUST AND PROVIDE FUSED DISCONNECT AS REQUIRED.
- 7. PROVIDE UNIT WITH CARRIER WALL MOUNTED C02 SENSOR. OUTSIDE AIR SHALL HAVE A MINIMUM SETPOINT OF ZERO AND THE DAMPER SHALL MODULATE OPEN AS REQUIRED TO SATISFY THE C02 SENSOR. THE OSA CFM LISTED IN THIS SCHEDULE SHALL BE THE MAXIMUM OSA DAMPER SETPOINT (IF NOT IN ECONOMIZER MODE). THE OUTSIDE AIR DAMPER SHALL CLOSE DURING THE UNOCCUPIED MODE.
- 8. PROVIDE 2" PLEATED MERV 8 FILTER AND FILTER RACK WITH 4 EXTRA SETS PER UNIT.
- 9. MAXIMUM "A-WEIGHTED" SUPPLY AIR SOUND RATINGS FOR UNITS 2-18 TONS = 95 DB @ 125 HZ, 90 DB @ 250 HZ, PER ARI STANDARDS 270 & 370.
- 10. PROVIDE A WATER LEVEL MONITOR IN THE PRIMARY DRAIN PAN INTERLOCKED WITH UNIT FOR UNIT SHUT-DOWN ON DETECTION OF WATER WHEN THE PRIMARY DRAIN IS PLUGGED.

	EXHAUST FAN SCHEDULE												
OVANDOL	ADEA OFDVED	LINIT TYPE		BLO	WER		ELECT	RICAL	MAXIMUM	OPERATING WEIGHT	MANUEACTURED AND MODEL	DEMARKO.	
SYMBOL	AREA SERVED	UNIT TYPE	CFM	ESP	MAXIMUM RPM	DRIVE	HP/W	V/Ø	SONES	(LBS)	MANUFACTURER AND MODEL	REMARKS	
<u>EF-1</u>		CEILING CABINET	75	.375	980	DIRECT	36.2 W	115/1	1.5	15	COOK MODEL GC-146	1,2,3	
<u>EF-2</u>		CEILING CABINET	100	.375	1075	DIRECT	46.5 W	115/1	2.5	15	COOK MODEL GC-148	1,2,3	
<u>EF-3</u>		CEILING CABINET	150	.375	1160	DIRECT	57.7 W	115/1	3.5	15	COOK MODEL GC-186	1,2,3	

#### REMARKS

- 1. APPROVED ALTERNATE MANUFACTURERS: ACME, GREENHECK, PENNBARRY, TWIN CITY FAN COMPANY, SOLER & PALAU AND BARRY BLOWER.
- 2. PROVIDE UNIT WITH MANUFACTURER'S ALUMINUM ROOF CAP (FLAT ROOF) EQUAL TO COOK MODEL PR (W/ INTEGRAL BIRD SCREEN AND ROOF CURB), MANUFACTURER'S STEEL ROOF JACK (SLOPED ROOF) EQUAL TO COOK MODEL RJ (W/ INTEGRAL BIRD SCREEN, FLASHING FLANGE AND BLACK EPOXY FINISH), MANUFACTURER'S WALL CAP EQUAL TO COOK MODEL WCG (W/ INTEGRAL BIRD SCREEN), BACKDRAFT DAMPER, OUTLET FLEX DUCT CONNECTION, STANDARD PLUG DISCONNECT, PRE-WIRED FAN SPEED CONTROLLER, THERMAL OVERLOAD PROTECTION, HANGING VIBRATION ISOLATORS, AND WHITE ALUMINUM GRILLE.
- 3. PROVIDE UNIT WITH MANUFACTURER'S ALUMINUM ROOF CAP (FLAT ROOF) EQUAL TO COOK MODEL PR (W/ INTEGRAL BIRD SCREEN AND ROOF CORB), MANUFACTURER'S STEEL ROOF JACK (SLOPED ROOF) EQUAL TO COOK MODEL RJ (W/ INTEGRAL BIRD SCREEN, FLASHING FLANGE AND BLACK EPOXY FINISH), MANUFACTURER'S WALL CAP EQUAL TO COOK MODEL WCG (W/ INTEGRAL BIRDSCREEN), BACKDRAFT DAMPER, INLET AND OUTLET FLEX DUCT CONNECTIONS, STANDARD PLUG DISCONNECT, PRE-WIRED FAN SPEED CONTROLLER, THERMAL OVERLOAD PROTECTION, AND HANGING VIBRATION ISOLATORS.
- 4. PROVIDE UNIT WITH MANUFACTURER'S BACKDRAFT DAMPER, INLET AND OUTLET FLEX DUCT CONNECTIONS, PRE-WIRED ELECTRICAL DISCONNECT SWITCH, SAHA BELT GUARD MOTOR COVER, THERMAL OVERLOAD PROTECTION (120 VOLT ONLY), POWDER COAT STANDARD GRAY FINISH, AND HANGING VIBRATION ISOLATORS.
- 5. PROVIDE UNIT WITH MANUFACTURER'S ROOF CURB W/ DAMPER TRAY AND BACKDRAFT DAMPER, THERMAL OVERLOAD PROTECTION (120 VOLT ONLY), PRE-WIRED NEWA 3R ELECTRICAL DISCONNECT SWITCH, AND INTEGRAL BIRD SCREEN.
- 6. PROVIDE UNIT WITH MANUFACTURER'S ROOF CURB (VENTED ROOF CURB IF EXHAUST DUCT IS SHAFTED RATHER THAN WRAPPED), THERMAL OVERLOAD PROTECTION (120 VOLT ONLY), PRE-WIRED NEMA 3R ELECTRICAL DISCONNECT SWITCH, HINGED SUB BASE, GREASE TERMINATOR, AND U.L. 762 RATING.
- 7. CONTROL FAN WITH SEPARATE WALL SWITCH, INTERLOCK WITH LIGHT SWITCH, HEAT RISE T-STAT, PUSH BUTTON DIGITAL COUNTDOWN TIMER SWITCH WITH 5-15-30 MINUTE AND 19-4 HOUR PRESETS, 7-DAY PROGRAMMABLE TIMER SWITCH, LIGHTING CONTROL PANEL, 7-DAY PROGRAMMABLE T-STAT (EQP-#) AUXILIARY CONTACT FOR FAN OPERATION DURING OCCUPIED HOURS

			DUC	(LE	SS	SPLI	T HI	GH '	WAI	LL C	COOL	ING	UNIT SCHEDULE	
SYMBOL	AREA SERVED	NOMINAL	UNIT TYPE	SUPP	LY FAN		CAPACITY °F OSA		LECTRICA ITDOOR U		MINIMUM	INDOOR / OUTDOOR	MANUFACTURED AND MODEL	REMARKS
SYMBOL	AREA SERVED	TONS	UNITTYPE	CFM	VIØ	TOTAL (MBH)	SENSIBLE (MBH)	MCA	МОСР	V/Ø	SEER	WEIGHT (LBS)	MANUFACTURER AND MODEL	REWARKS
FC-1, CU-1		1.0	HIGH WALL COOLING ONLY	305	THRU O/U	12.0	8.5	11	15	208/1	19.0	20 / 65	CARRIER FAN COIL MODEL 40MHH12 CARRIER CONDENSING UNIT MODEL 38MHRBC12	1,2,3,4,5,6
FC-1, CU-1		1.5	HIGH WALL COOLING ONLY	550	THRU O/U	18.0	13.0	15	20	208/1	19.0	25 / 75	CARRIER FAN COIL MODEL 40MHH18 CARRIER CONDENSING UNIT MODEL 38MHRBC18	1,2,3,4,5,6
FC-1, CU-1		2.0	HIGH WALL	640	THRU	25.0	18.0	18	25	208/1	18.5	35 / 95	CARRIER FAN COIL MODEL 40MHH24	1,2,3,4,5,6

#### REMARKS

- 1. APPROVED ALTERNATE MANUFACTURERS: CARRIER, LENNOX, MITSUBISHI, PANASONIC, SAMSUNG, LG, DAIKIN, OR APPROVED EQUAL BY ENGINEER.
- 2. CONTROL UNIT WITH MANUFACTURER'S HARD-WIRED WALL MOUNTED 7 DAY PROGRAMMABLE THERMOSTAT.
- 3. PROVIDE MANUFACTURERS CRANKCASE HEATER, LOW AMBIENT CONTROLS & (TO 0°F) WIND BAFFLES, REFRIGERATION LINE SET SIZED BY MANUFACTURER (LONG LINE APPLICATION), AND TAMPER PROOF PORT CAPS.
- 4. PROVIDE WITH MIRO INDUSTRIES HEAVY DUTY MECHANICAL GALVANIZED ROOF SUPPORT WITH ADJUSTABLE SUPPORT LEGS. SUPPORT SHALL EXTEND A MINIMUM OF 6" BEYOND EQUIPMENT IN EACH DIRECTION. BOLT EQUIPMENT TO MECHANICAL SUPPORT. OR PROVIDE 18" CURB, REFERENCE CONDENSING CURB DETAIL.
- ENDINE SEASON OF THE PROVIDE WITH MANUFACTURER'S CONDENSATE PUMP, LITTLE GIANT MINI CONDENSATE PUMP, CONCEAL PUMP BEHIND UNIT WITHIN MOUNTING BRACKET ASSEMBLY. PUMP SHALL BE POWERED BY FAN COIL.
- 6. ELECTRICAL TO PROVIDE DISCONNECT.

	TYPE I EXHAUST FAN SCHEDULE													
CVMDOL	ADEA CEDVED	LINIT TVDF	BLOWER				ELECTRICAL		MAXIMUM	OPERATING WEIGHT	MANUFACTURED AND MODEL	DEMARKS		
SYMBOL	AREA SERVED UNIT TYPE		CFM	ESP	MAXIMUM RPM	DRIVE	HP	HP V/Ø		(LBS)	MANUFACTURER AND MODEL	REMARKS		
GF-D5A	GREASE HOOD H-D5A	ROOF MOUNTED UP BLAST	2900	1.0	1725	DIRECT	2.0	460/3	18.9	200	CAPTIVEAIRE MODEL DU180HFA WITH DEMAND VENTILATION	1,2,3,4		
GF-D5B	GREASE HOOD H-D5B	ROOF MOUNTED UP BLAST	2900	1.0	1725	DIRECT	2.0	460/3	18.9	200	CAPTIVEAIRE MODEL DU180HFA WITH DEMAND VENTILATION	1,2,3,4		

#### REMARKS

- 1. EXHAUST FANS SHALL BE THE SAME MANUFACTURER AS THE TYPE I HOOD(S).
- 2. PROVIDE UNIT WITH MANUFACTURER'S ROOF CURB, HINGED SUB BASE, GREASE TERMINATOR, AND U.L. 762 RATING.
- 3. CONTROL FAN WITH WALL MOUNTED CONTROL SYSTEM.
- 4. ELECTRICAL TO PROVIDE DISCONNECT.

					EXH	AUST	HOOE	SCH	EDULE	Ξ	
SYMBOL	TYPE		MENSIONS RE AREA)		EXHAUST AIR		MAKE-	UP AIR	WEIGHT	MANUFACTURER AND MODEL	REMARKS
STIVIDOL	TTPE	LENGTH	WIDTH	AIRFLOW CFM	DUCT CONNECITON	MAX S.P. LOSS	AIRFLOW CFM	DUCT CONNECTION	LBS.	WIANOPACTORER AND WODEL	REWARNS
<u>H-D5A</u>	TYPE I EXHAUST HOOD (GF-D5A) EXHAUST FAN	15'-6"	60"	2900	(2) 12X12	-0.886			1350	CAPTIVE AIRE MODEL 6024 ND-2 DEMAND VENTILATION TYPE I	1,2,3,4,5
<u>H-D5B</u>	TYPE I EXHAUST HOOD (GF-D5B) EXHAUST FAN	15'-6"	60"	2900	(2) 12X12	-0.886			1350	CAPTIVE AIRE MODEL 6024 ND-2 DEMAND VENTILATION TYPE I	1,2,3,4,5
H-D5C	TYPE II EXHAUST DISH HOOD (EF-D5A) EXHAUST FAN	48"	48"	700	10"Ø	-0.123			200	CAPTIVE AIRE MODEL 4824 VHB-G TYPE II	1,6,7

#### REMARKS:

- ALTERNATE MANUFACTURERS GREENHECK, ACCUREX, E-CON AIR, AND DUO-AIRE.
- HOODS WILL BE MOUNTED ABOVE A HALF HEIGHT DIVIDING WALL.
- PROVIDE WITH PRE-WIRED CONTROLS WITH WALL MOUNTED CONTROLS FOR TWO FANS (INCLUDING VFDs, CONTACTORS, AND TEMPERATURE SENSOR) AND ENERGY MANAGEMENT SYSTEM OVERRIDE.
- 4. PROVIDE HOOD WITH FILTERS, STAINLESS STEEL CEILING SKIRT, EXHAUST COLLARS AND INTERIOR LIGHTS.
- PROVIDE HOOD WITH MANUFACTURER'S CHEMICAL FIRE SUPPRESSION SYSTEM INCLUDING MECHANICAL GAS VALVE FOR SHUTDOWN OF MAIN GAS LINE TO COOKING EQUIPMENT. SYSTEM SHALL BE CONNECTED TO BUILDING FIRE ALARM SYSTEM BY FIRE
- 6. PROVIDE UNIT WITH EXHAUST COLLAR, STAINLESS STEEL CEILING SKIRT, DRAIN GUTTER.
- CONTROL EXHAUST HOOD WITH WALL SWITCH. SEE EF-D5A EXHAUST FAN.



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MUSGROVE ENGINEERING, P.A. 234 S. Whisperwood Way Boise, Idaho 83709

208.384.0585 www.musgrovepa.com OVER 40 YEARS OF EXCELLENCE

Project No. 22-104



efferson Elementary Scho ddition and Remodel

DATE: December 9, 2022 LKV PROJECT #: -REVISIONS:

DRAWN BY: CD CHECKED BY: BC

Design Development

AWING NO.

M-7.0

	ELECTRIC HEATER SCHEDULE												
SYMBOL	ADEA CEDVED	LINIT TYPE		MANUEACTURER AND MODEL	DEMARKS								
SYMBOL	AREA SERVED	UNIT TYPE	CFM	RPM	HP	KW	STEPS	V/Ø	AMPS	MANUFACTURER AND MODEL	REMARKS		
EH-1.1	VESTIBULE	CEILING RECESS MOUNTED	300	1400	1/8	2	1	208/1	9.6	QMARK MODEL CDF SERIES WITH RECESSED ENCLOSURE	1,4,6		
EH-1.2	HALL ENTRY	CEILING RECESS MOUNTED	300	1400	1/8	2	1	208/1	9.6	QMARK MODEL CDF SERIES WITH RECESSED ENCLOSURE	1,4,6		
<u>EH-1.3</u>	RISER	SURFACE MOUNTED	245	1400	1/8	2	1	208/1	9.6	MARKEL MODEL 3420 SERIES	1,2,3,5		

#### REMARKS:

- 1. APPROVED ALTERNATE MANUFACTURERS: BRASCH, QMARK, MARKEL, INDEECO, OUELLET, AND CHROMALOX.
- 2. PROVIDE UNIT WITH AN INTEGRAL THERMOSTAT. THERMOSTAT SHALL BE COVERED WITH A TAMPER-PROOF ACCESS COVER.
- 3. PROVIDE SURFACE MOUNTING KIT.
- 4. ADJUST HEATER TO OPERATE AT 60°F.
- 5. ADJUST HEATER TO OPERATE AT 50°F.
- 6. PROVIDE REMOTE LINE VOLTAGE THERMOSTAT ON WALL. FINISH THERMOSTAT WITH LOCKABLE COVER.

					DE	STF	RAT	IFIC	ATIC	N FAN SCHEDULE	
CVMDOL							WEIGHT	MAXIMUM	MANUEA CTUDED AND MODEL	DEMARKS	
SYMBOL	AREA SERVED	CFM	RPM	V/Ø	WATTS	AMPS	LBS.	dBA	MOUNTING HEIGHT	MANUFACTURER AND MODEL	REMARKS
<u>DSF-1.1</u>	GYM	1128	2700	120/1	175	1.48	14	64	45'	AIRIUS MODEL AIR PEAR A-45-P2	1,2,3,4,5
<u>DSF-1.2</u>	GYM	1128	2700	120/1	175	1.48	14	64	45'	AIRIUS MODEL AIR PEAR A-45-P2	1,2,3,4,5

#### REMARKS:

- 1. APPROVED ALTERNATE MANUFACTURERS: WITH PRIOR APPROVAL OF ENGINEER.
- 2. PROVIDE UNIT WITH PCS MOTOR, SEALED BEARINGS, 6' CORD, GUARD GRILLE, STATOR, 6' STEEL SAFETY CABLE AND HANGING BRACKET.
- 3. CONTROL UNIT WITH MANUFACTURES WALL MOUNTED (TRIAC-120-1.5 FOR PCS MOTOR) SPEED CONTROLLER, IN ADDITION TO THE SPEED CONTROLLER, CONTROL SCHEDULE OF USE BY DDC.
- 4. PROVIDE OFF WHITE COLOR.
- 5. FAN SHALL BE INTEGRATED TO THE FIRE CONTROL PANEL. INCLUDES A 10-30 VDC PILOT RELAY FOR SEAMLESS FIRE CONTROL PANEL INTEGRATION. THE PILOT RELAY CAN BE WIRED NORMALLY OPEN OR NORMALLY CLOSED IN THE FIELD.



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NOT FOR CONSTRUCTION

ementary School Remodel n Elei and l Jefferson | Addition a

DATE: December 9, 2022 LKV PROJECT #: -REVISIONS:

DRAWN BY: CD CHECKED BY: BC

Design Development

DRAWING NO.

	SUPPLY GRILLE SCHEDULE											
SYMBOL	NOMINAL SIZE	NECK / RUNOUT SIZE	CFM RANGE	REMARKS								
G-1 CFM SIZE	6X6	6X6	0-180	1,2,3,4								
G-2 CFM SIZE	12X10	12X10	180-575	1,2,3,4								
G-3 CFM SIZE	14X10	14X10	400-700	1,2,3,4								

#### REMARKS

- 1. WALL GRILLE SIZES BASED ON TITUS MODEL 272F, DOUBLE DEFLECTION ADJUSTABLE BLADES, 3/4" SPACING, WHITE FINISH. APPROVED ALTERNATE MANUFACTURERS INCLUDE ANEMOSTAT, CARNES, J&J REGISTER, TUTTLE & BAILEY, NAILOR, METAL-AIRE, KRUEGER, PRICE, AND UNITED ENERTECH.
- 2. SIZES BASED ON A MAXIMUM NC LEVEL OF 25.
- 3. ALL OF THE GRILLES SHOWN IN THIS SCHEDULE MAY NOT BE USED. REFERENCE THE HVAC PLAN FOR GRILLE CALL-OUTS AND THE QUANTITY OF EACH SIZE REQUIRED.
- 4. WHENEVER THERE IS A DISCREPANCY BETWEEN THE RUNOUT DUCT SIZE SHOWN ON THE PLANS AND THAT SHOWN IN THE SCHEDULE, ALWAYS USE THE LARGER OF THE TWO DUCT SIZES.

	DIFF	USER S	CHEDULE	=
SYMBOL	NOMINAL SIZE	NECK / RUNOUT SIZE	CFM RANGE	REMARKS
D-1 CFM 6"Ø	6X6	6"Ø	0 - 90	1,2,3,4,5,6,7
D-2 CFM 8"Ø	9X9	8"Ø	90 - 200	1,2,3,4,5,6,7
D-3 CFM 10"Ø	12X12	10"Ø	200 - 350	1,2,3,4,5,6,7
D-4 CFM 12"Ø	15X15	12"Ø	300 - 500	1,2,3,4,5,6,7
D-5 CFM 14"Ø	15X15	14"Ø	400 - 650	1,2,3,4,5,6,7
D-6 CFM 16"Ø	18X18	16"Ø	600 - 900	1,2,3,4,5,6,7
D-7 CFM 21X21	21X21	21X21	900 - 1400	1,2,3,4,5,6,7
D-8 CFM 8"Ø	48" (3)-3/4" SLOT, 8" OVAL	8"Ø	0 - 175	2,4,5,6,7,8
D-9 CFM 12"Ø	48" (3)-3/4" SLOT, 12" OVAL	12"Ø	0 - 240	2,4,5,6,7,8
D-10 CFM 12"Ø	72" (3)-3/4" SLOT, 10" OVAL	10"Ø	0 - 275	2,4,5,6,7,8
D-11 CFM 12"Ø	72" (3)-3/4" SLOT, 12" OVAL	12"Ø	250 - 360	2,4,5,6,7,8
D-12 CFM 8"Ø	24X24 MODULE 8"Ø NECK	8"Ø"	0 - 200	2,4,5,6,7,9
D-13 CFM 10"Ø	24X24 MODULE 10"Ø NECK	10"Ø"	100 - 400	2,4,5,6,7,9
D-14 CFM 18"Ø	40"Ø	18"Ø	700 - 1075	2,4,5,6,7,10

#### REMARK

- SIZES BASED ON TITUS MODEL TDCA SERIES, HORIZONTAL TO VERTICAL ADJUSTABLE DISCHARGE. APPROVED ALTERNATE MANUFACTURERS INCLUDE ANEMOSTAT, J&J REGISTER, NAILOR, METAL-AIRE, TUTTLE & BAILEY, KRUEGER, PRICE, AND UNITED ENERTECH.
- 2. SIZES BASED ON A MAXIMUM NC LEVEL OF 25.
- 3. ALL DIFFUSERS LOCATED IN LAY-IN CEILING AREAS SHALL BE BORDER TYPE 3 AND BE MOUNTED IN MANUFACTURER PROVIDED 24"x24" PANELS. ALL DIFFUSERS LOCATED IN HARD CEILING AREAS SHALL BE BORDER TYPE 6 (BEVELED) SURFACE MOUNTED. SEE ARCHITECTURAL PLANS FOR LOCATIONS OF VARIOUS CEILING TYPES.
- 4. SEE HVAC FLOOR PLANS FOR DIRECTIONAL THROW REQUIREMENTS FOR EACH DIFFUSER.
- 5. ALL OF THE DIFFUSERS SHOWN IN THIS SCHEDULE MAY NOT BE USED. REFERENCE THE HVAC PLAN FOR DIFFUSER CALL-OUTS AND THE QUANTITY OF EACH SIZE REQUIRED.
- 6. WHENEVER THERE IS A DISCREPANCY BETWEEN THE RUNOUT DUCT SIZE SHOWN ON THE PLANS AND THAT SHOWN IN THE SCHEDULE, ALWAYS USE THE LARGER OF THE TWO DUCT SIZES.
- 7. WHITE FINISH.
- 8. SIZES BASED ON TITUS MODEL ML-38 WITH PLENUM MP-38. DIFFUSERS LOCATED IN LAY-IN CEILING AREAS SHALL BE BORDER TYPE 3 AND HARD CEILING AREAS SHALL BE BORDER TYPE 6. SEE ARCHITECTURAL PLANS FOR LOCATIONS OF VARIOUS CEILING TYPES. HARD CEILING APPLICATION SHALL BE CLIP TYPE AND NO SCREWS SHALL BE USED ON DIFFUSER. APPROVED ALTERNATE MANUFACTURERS INCLUDE ANEMOSTAT, J&J REGISTER, NAILOR, METAL-AIRE, TUTTLE & BAILEY, KRUEGER AND PRICE.
- 9. SIZES BASED ON TITUS MODEL PCS-DF SERIES. 4-WAY ADJUSTABLE DEFLECTORS (PATTERN CONTROLLER), VERTICAL/HORZONTAL WITH HINGED DROP PERFORATED FACE. APPROVED ALTERNATE MANUFACTURERS INCLUDE ANEMOSTAT, J&J REGISTER, NAILOR, METAL-AIRE, TUTTLE & BAILEY, KRUEGER, PRICE, AND UNITED ENERTECH
- 10. SIZES BASED ON TITUS MODEL TMRA, TYPE 3, ROUND CEILING DIFFUSER, STEEL CONSTRUCTION. APPROVED ALTERNATE MANUFACTURERS INCLUDE ANEMOSTAT, J&J REGISTER, NAILOR, METAL-AIRE, TUTTLE & BAILEY, KRUEGER, PRICE, AND UNITED ENERTECH.

RETURN & EXHAUST GRILLE SCHEDULE				
SYMBOL	NOMINAL SIZE	NECK / RUNOUT SIZE	CFM RANGE	REMARKS
R-1 6"Ø	8X8	6"Ø	0-80	1,2,3,4,5,6
R-2 8"Ø	10X10	8"Ø	80-180	1,2,3,4,5,6
R-3 10"Ø	12X12	10"Ø	180-300	1,2,3,4,5,6
R-4 6"Ø	22X10	6"Ø	0-80	1,2,3,4,5,6
R-5 8"Ø	22X10	8"Ø	80-180	1,2,3,4,5,6
R-6 10"Ø	22X10	10"Ø	180-300	1,2,3,4,5,6
R-7 12"Ø	22X22	12"Ø	300-500	1,2,3,4,5,6
R-8 14"Ø	22X22	14"Ø	500-750	1,2,3,4,5,6
R-9 22X10	22X10	22X10	500-1100	1,2,3,4,5,6
R-10 22X22	22X22	22X22	1100-2000	1,2,3,4,5,6
R-11 22X22	22X22	16"Ø	1100-1300	1,2,3,4,5,6
R-12 22X22	22X22	18"Ø	1100-1700	1,2,3,4,5,6
R-13 10X10	10X10	10X10	0-200	1,2,3,4,5,6
R-14 10X6	10X6	10X6	0-180	2,4,5,6,8
R-15 12X6	12X6	12X6	0-200	2,4,5,6,7
R-16 40X40	40X40	40X40	0-4200	2,4,5,6,7
R-17 18X14	18X14	18X14	0-1000	2,4,5,6,8
R-18 12X12	12X12	12X12	0-500	2,4,5,6,8
R-19 12X10	12X10	12X10	0-400	2,4,5,6,7
R-20 12X8	12X8	12X8	0-160	2,4,5,6,8

#### REMARKS:

- SIZES BASED ON TITUS MODEL 50F, ALUMINUM EGGCRATE RETURN GRILLE, 1/2" x 1/2" x 1" SPACING (SINGLE CORE). PROVIDE SQUARE TO ROUND TRANSITION (WHERE ROUND RUN-OUT INDICATED). APPROVED ALTERNATE MANUFACTURERS INCLUDE, ANEMOSTAT, CARNES, PRICE, NAILOR, METAL-AIRE, TUTTLE & BAILEY, KRUEGER, J&J REGISTER, AND UNITED ENERTECH.
- 2. SIZES BASED ON A MAXIMUM NC LEVEL OF 25.
- 3. ALL GRILLES LOCATED IN LAY-IN CEILING AREAS SHALL HAVE BORDER #3, UNLESS OTHERWISE INDICATED. ALL GRILLES LOCATED IN HARD CEILING AREAS SHALL HAVE BORDER #1, UNLESS OTHERWISE INDICATED. REFER TO ARCHITECTURAL PLANS FOR LOCATIONS OF VARIOUS CEILING TYPES. SHEET METAL DUCTWORK VISIBLE BEHIND GRILLE SHALL BE PAINTED FLAT BLACK.
- 4. ALL OF THE GRILLES SHOWN IN THIS SCHEDULE MAY NOT BE USED. REFERENCE THE HVAC PLAN FOR GRILLE CALL-OUTS AND THE QUANTITY OF EACH SIZE REQUIRED.
- 5. WHENEVER THERE IS A DISCREPANCY BETWEEN THE RUNOUT DUCT SIZE SHOWN ON THE PLANS AND THAT SHOWN IN THE SCHEDULE, ALWAYS USE THE LARGER OF THE TWO DUCT SIZES.
- 6. WHITE FINISH.
- 7. LOW WALL GRILLE SIZES BASED ON TITUS MODEL 33R, HEAVY DUTY STEEL, 14 GAUGE BLADES, 1/2" SPACING, 38° DEFLECTION, ALL-WELDED CONSTRUCTION. APPROVED ALTERNATE MANUFACTURERS INCLUDE ANEMOSTAT, CARNES, J&J REGISTER, NAILOR, TUTTLE & BAILEY, KRUEGER, PRICE, AND UNITED ENERTECH.
- 8. HIGH WALL GRILLE SIZES BASED ON TITUS MODEL 355 RL, STEEL BAR GRILLE, FIXED BLADES, 1/2" SPACING, 35° DEFLECTION, ADJUSTABLE OPPOSED BLADE DAMPER. APPROVED ALTERNATE MANUFACTURERS INCLUDE ANEMOSTAT, CARNES, J&J REGISTER, NAILOR, TUTTLE & BAILEY, KRUEGER, PRICE, AND UNITED ENERTECH.

LKV ARCHITECTS

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Design Development

DRAWING NO.

M-7.2



Area 'A'

Area 'D'

North Not to Scale

Area'B'

Area 'E'



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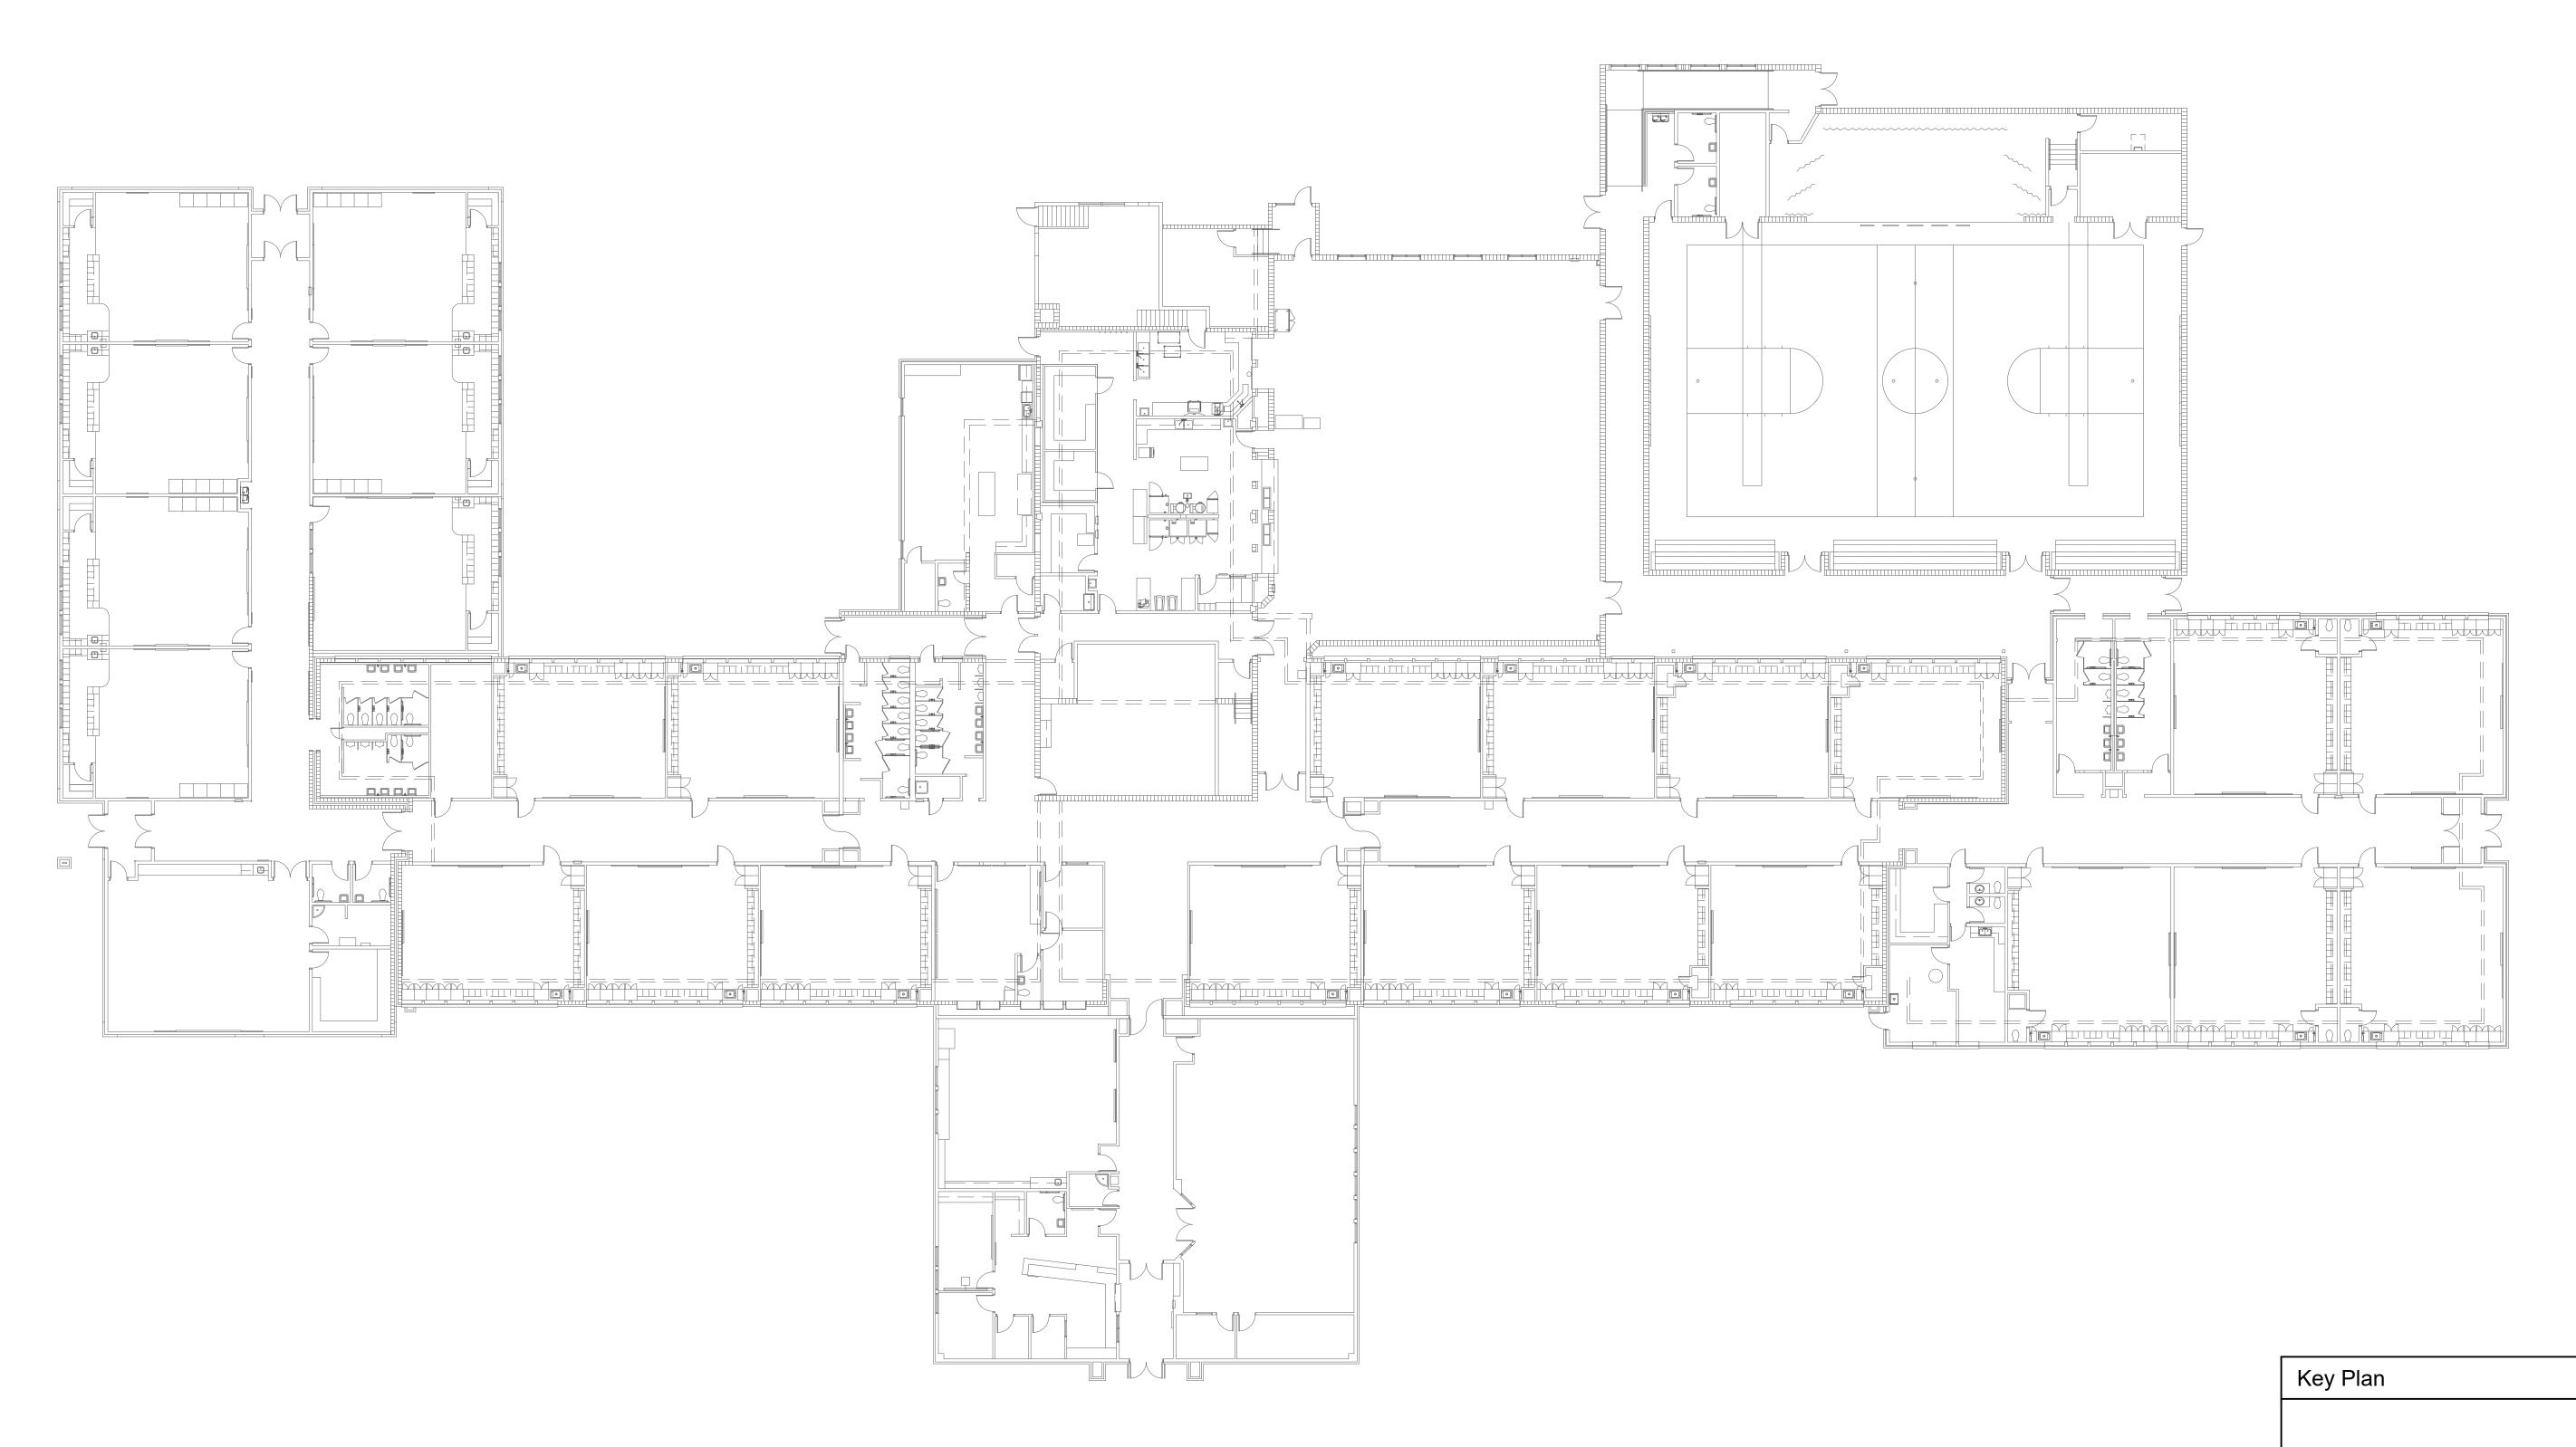
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M-8.0





# SYMBOL USED FOR NOTE CALLOUT.

1. KEYNOTES

Area'A'

Area 'D'

North Not to Scale

Area'B'

Area 'E'



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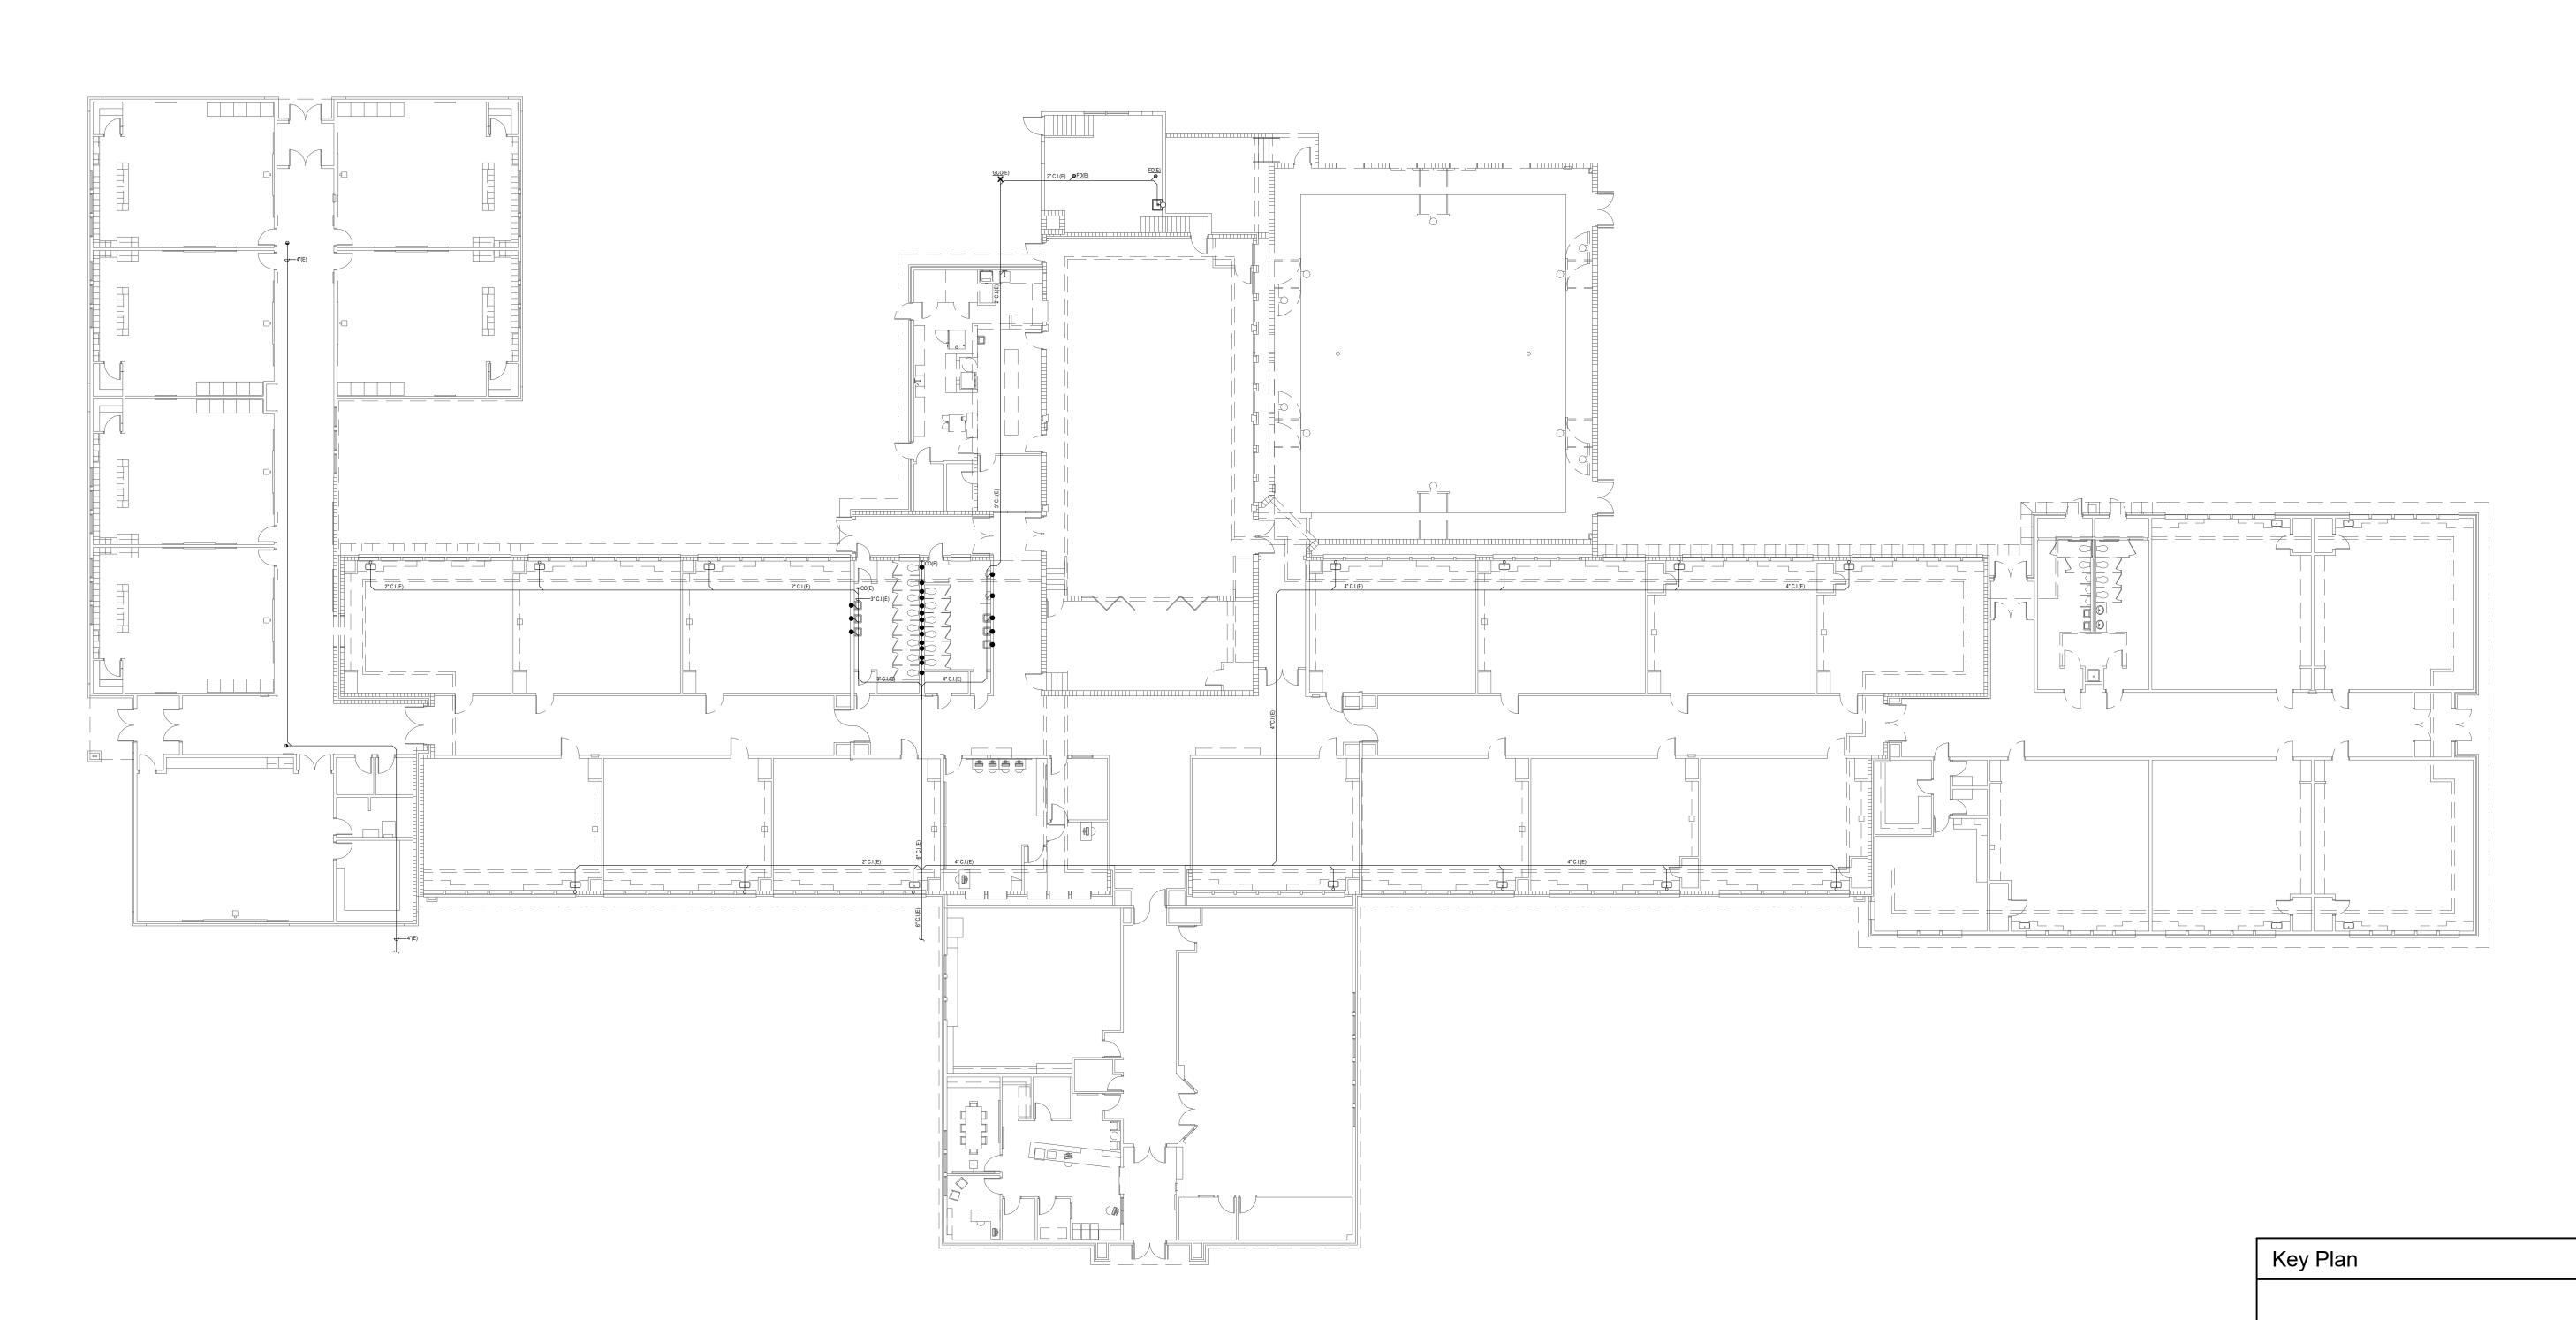
Jefferson Elementary School Addition and Remodel


DATE: December 9, 2022 LKV PROJECT #: -REVISIONS:


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Design Development

P-1.0





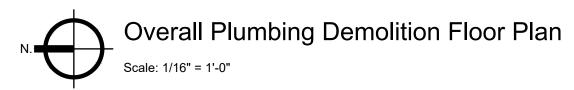
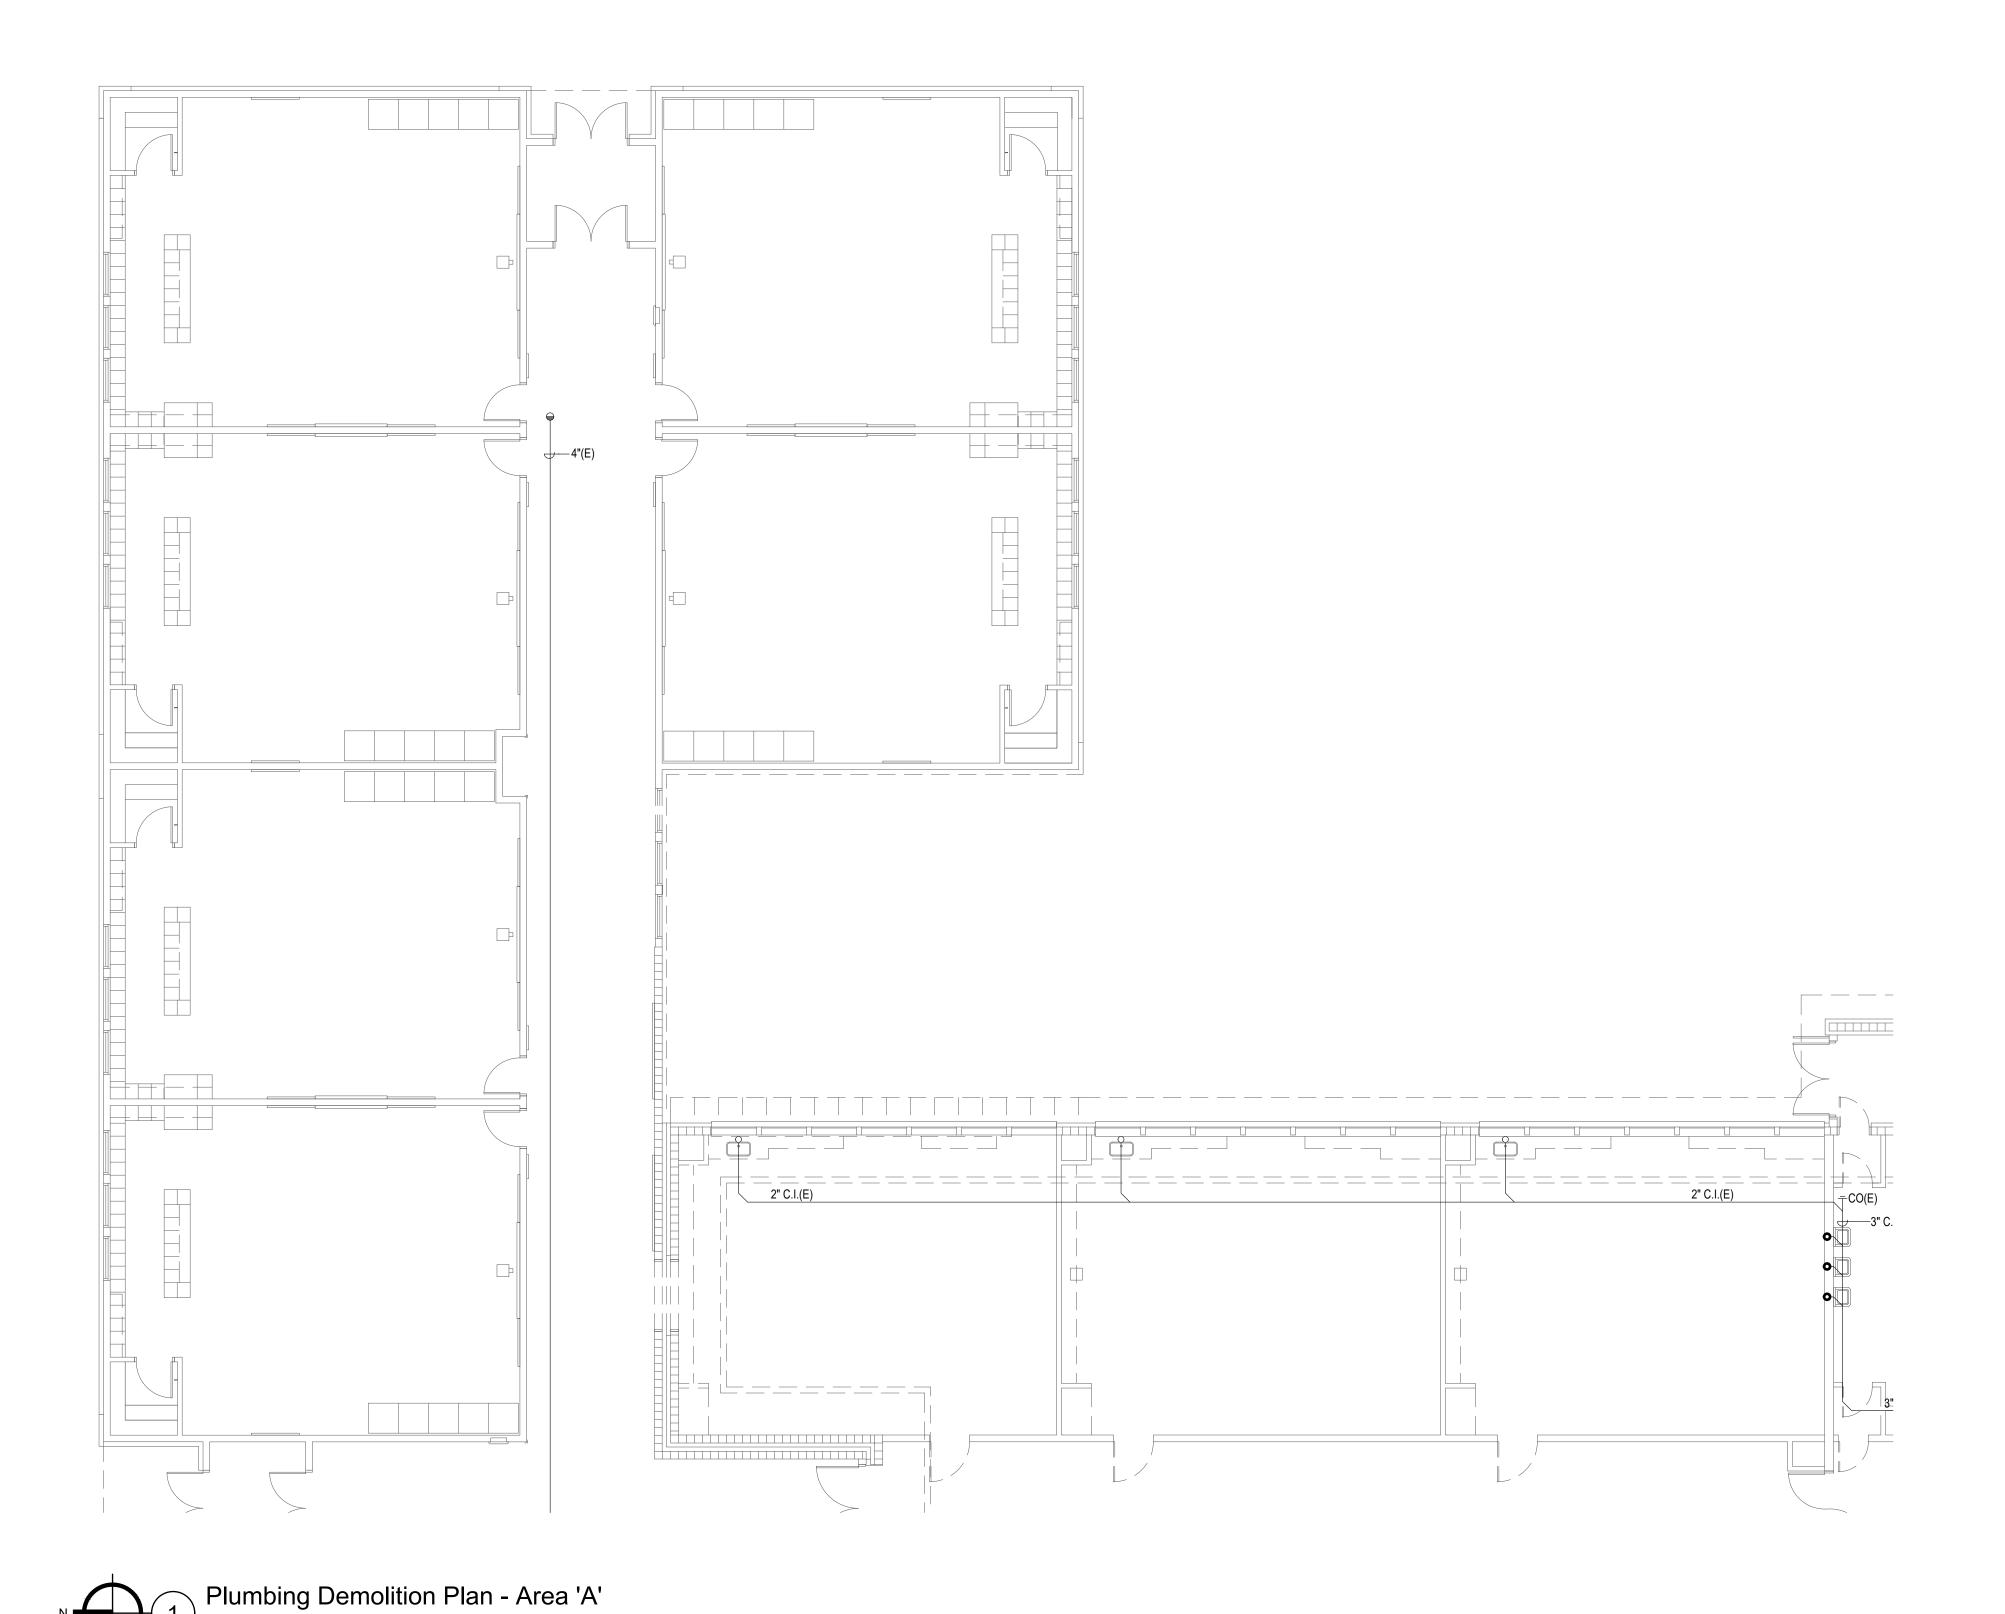
# SYMBOL USED FOR NOTE CALLOUT.

1. KEYNOTES



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P-1.1

Key Plan

Area 'A'


Area 'B'

Area 'C'

Area 'E'

North

Not to Scale

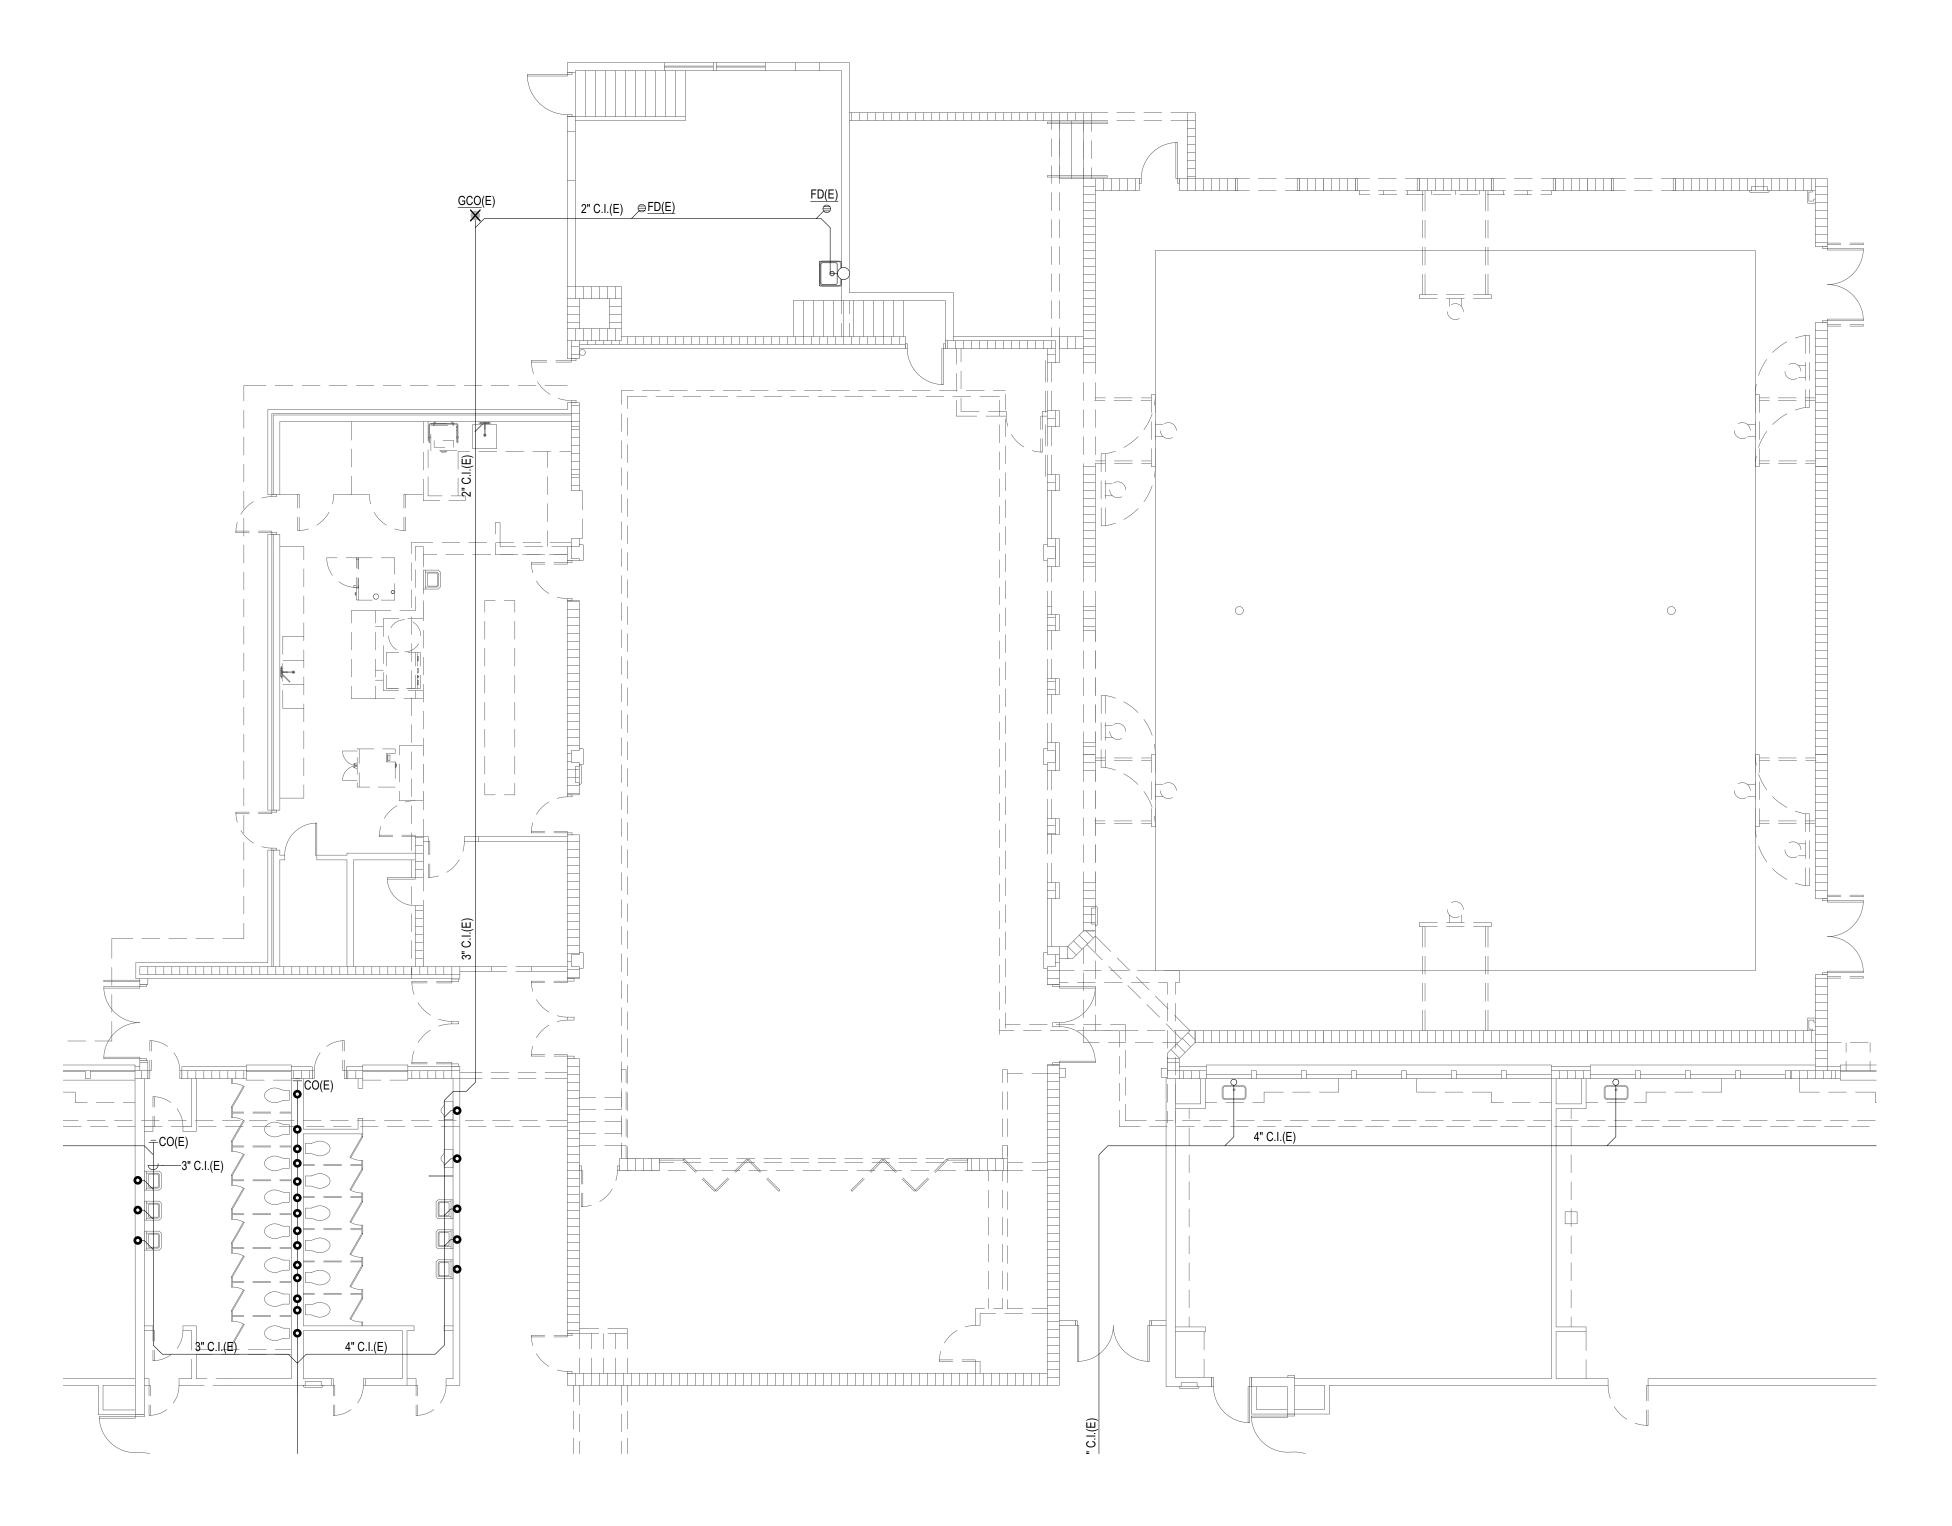

Plumbing Demolition Plan - Area 'B'

Scale: 1/8" = 1'-0"

# SYMBOL USED FOR NOTE CALLOUT.

1. KEYNOTES



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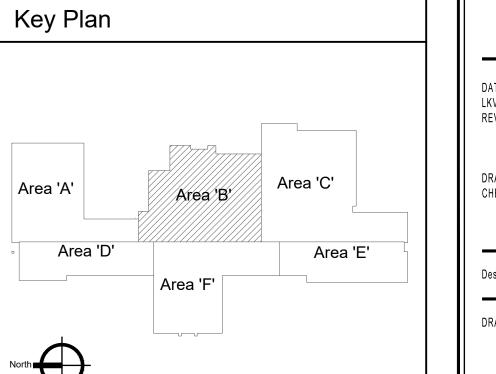


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Design Development

P-1.2

Plumbing Demolition Plan - Area 'C'

## **KEYED NOTES:**

# SYMBOL USED FOR NOTE CALLOUT.

1. KEYNOTES



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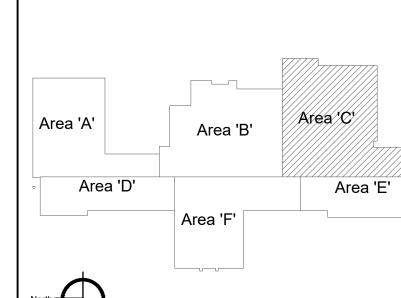
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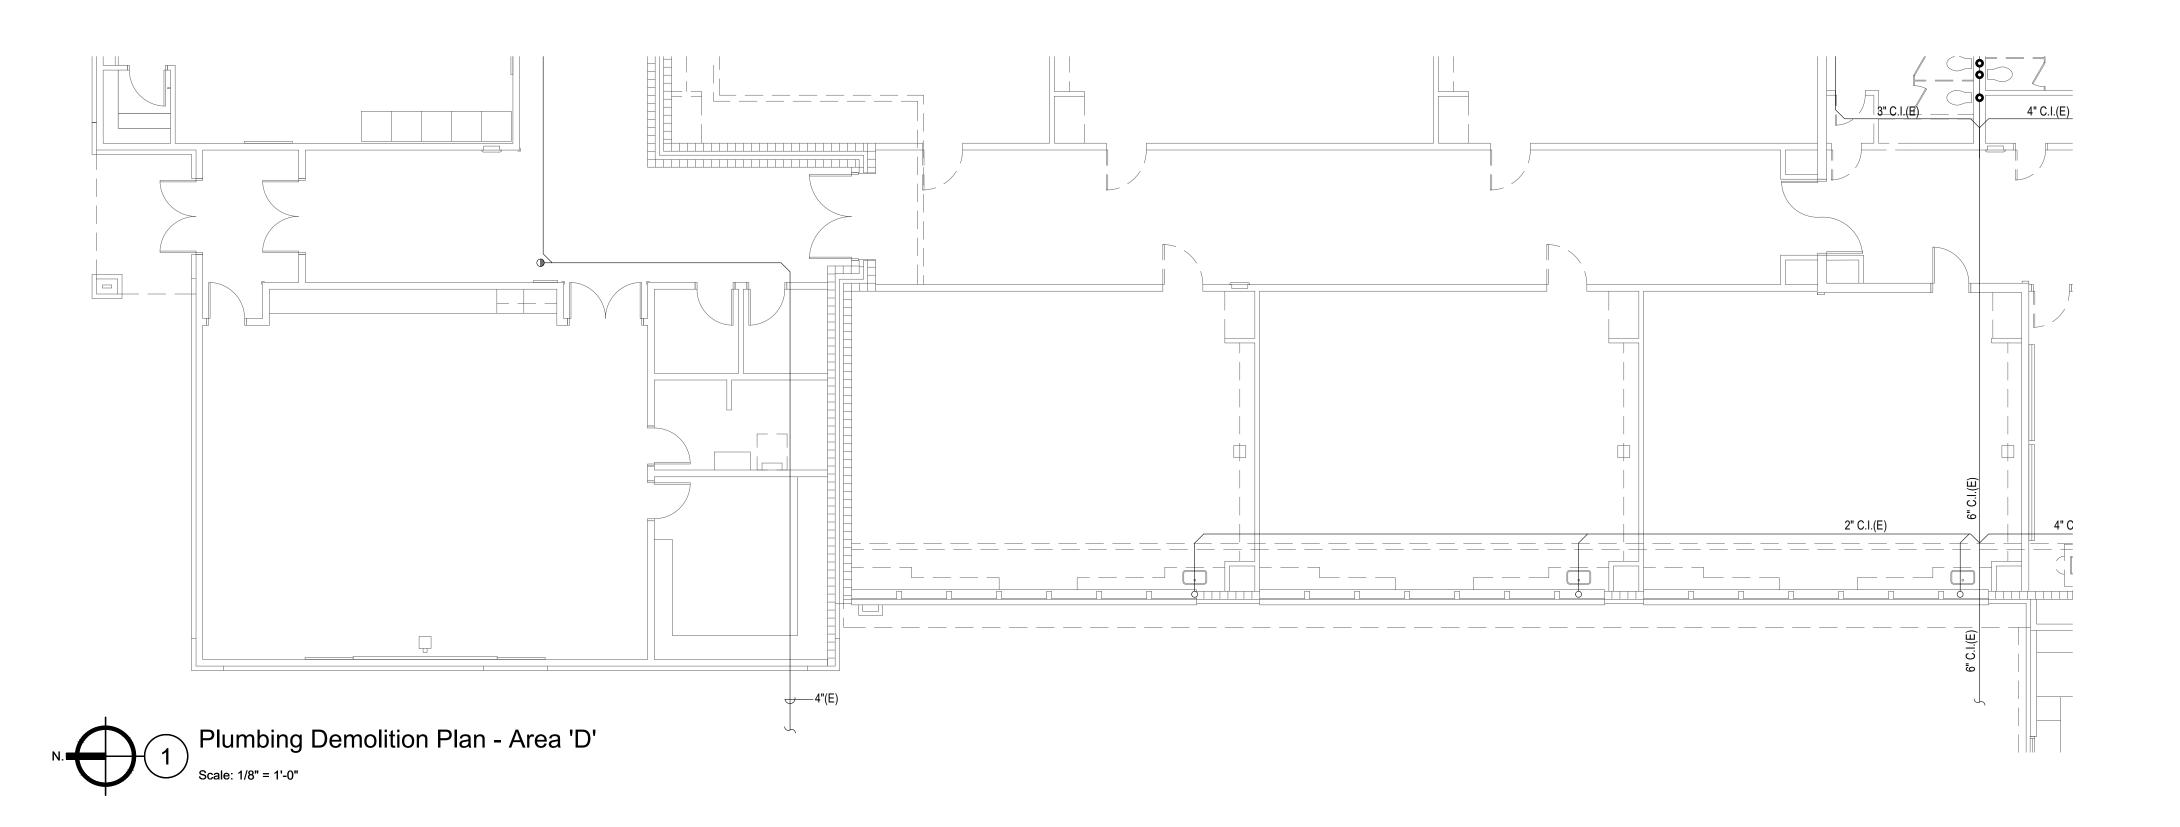
Design Development


DRAWING NO.

P-1.3

Key Plan





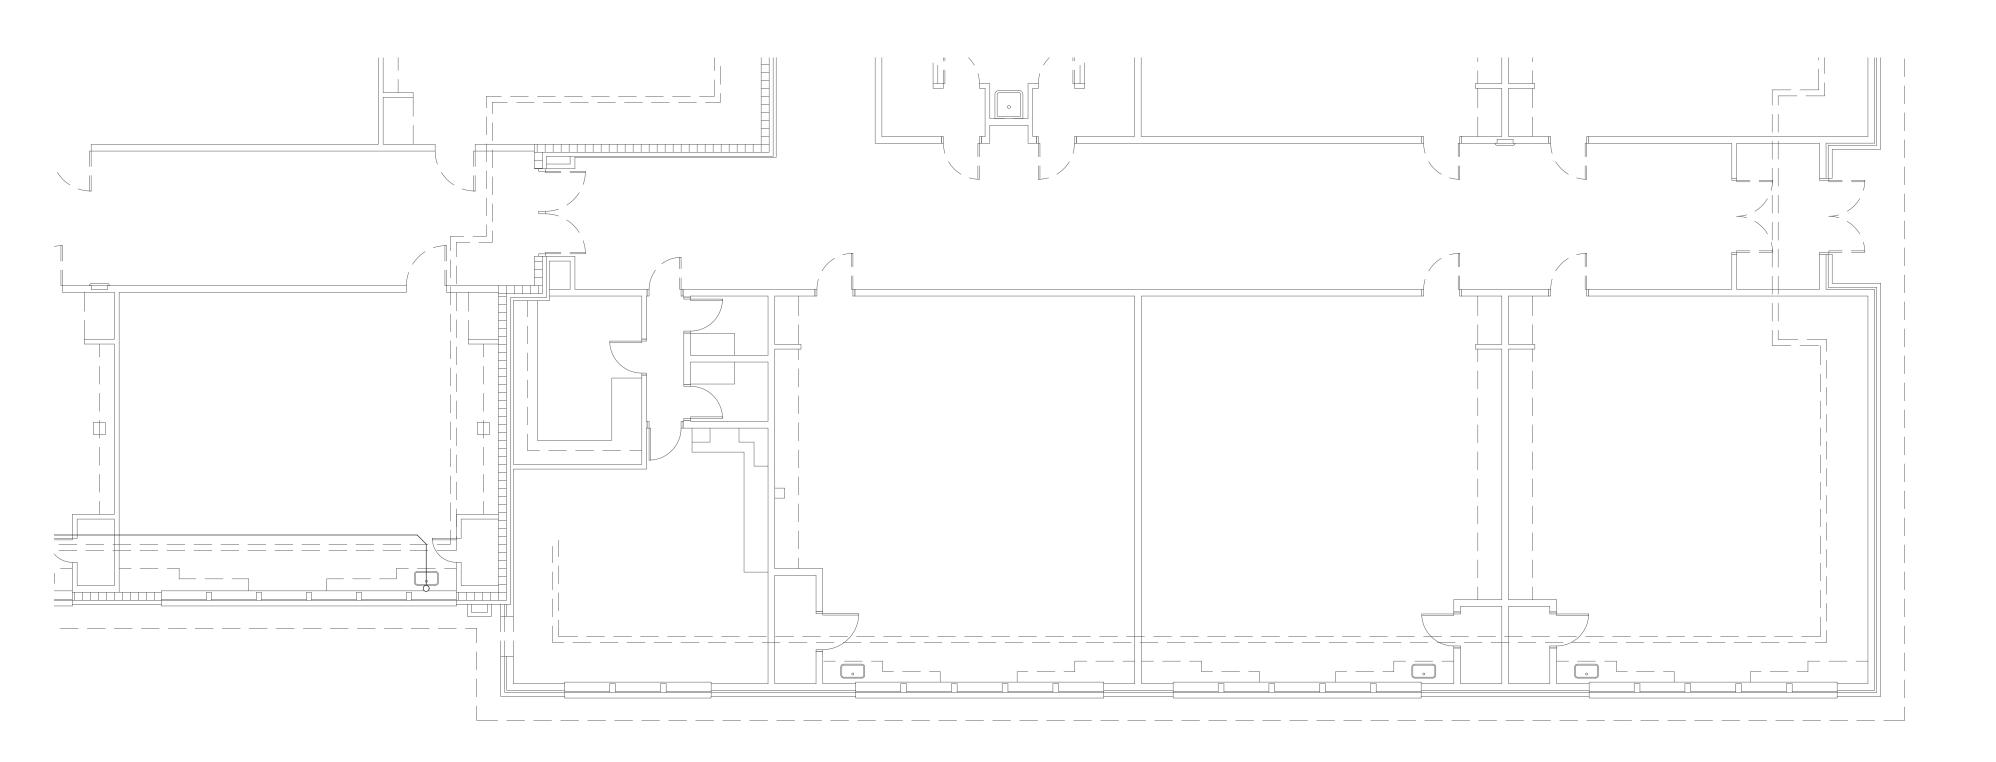



# SYMBOL USED FOR NOTE CALLOUT.

1. KEYNOTES

Key Plan

Area 'A'

//Area 'D'

Area 'B'

//Area/E//



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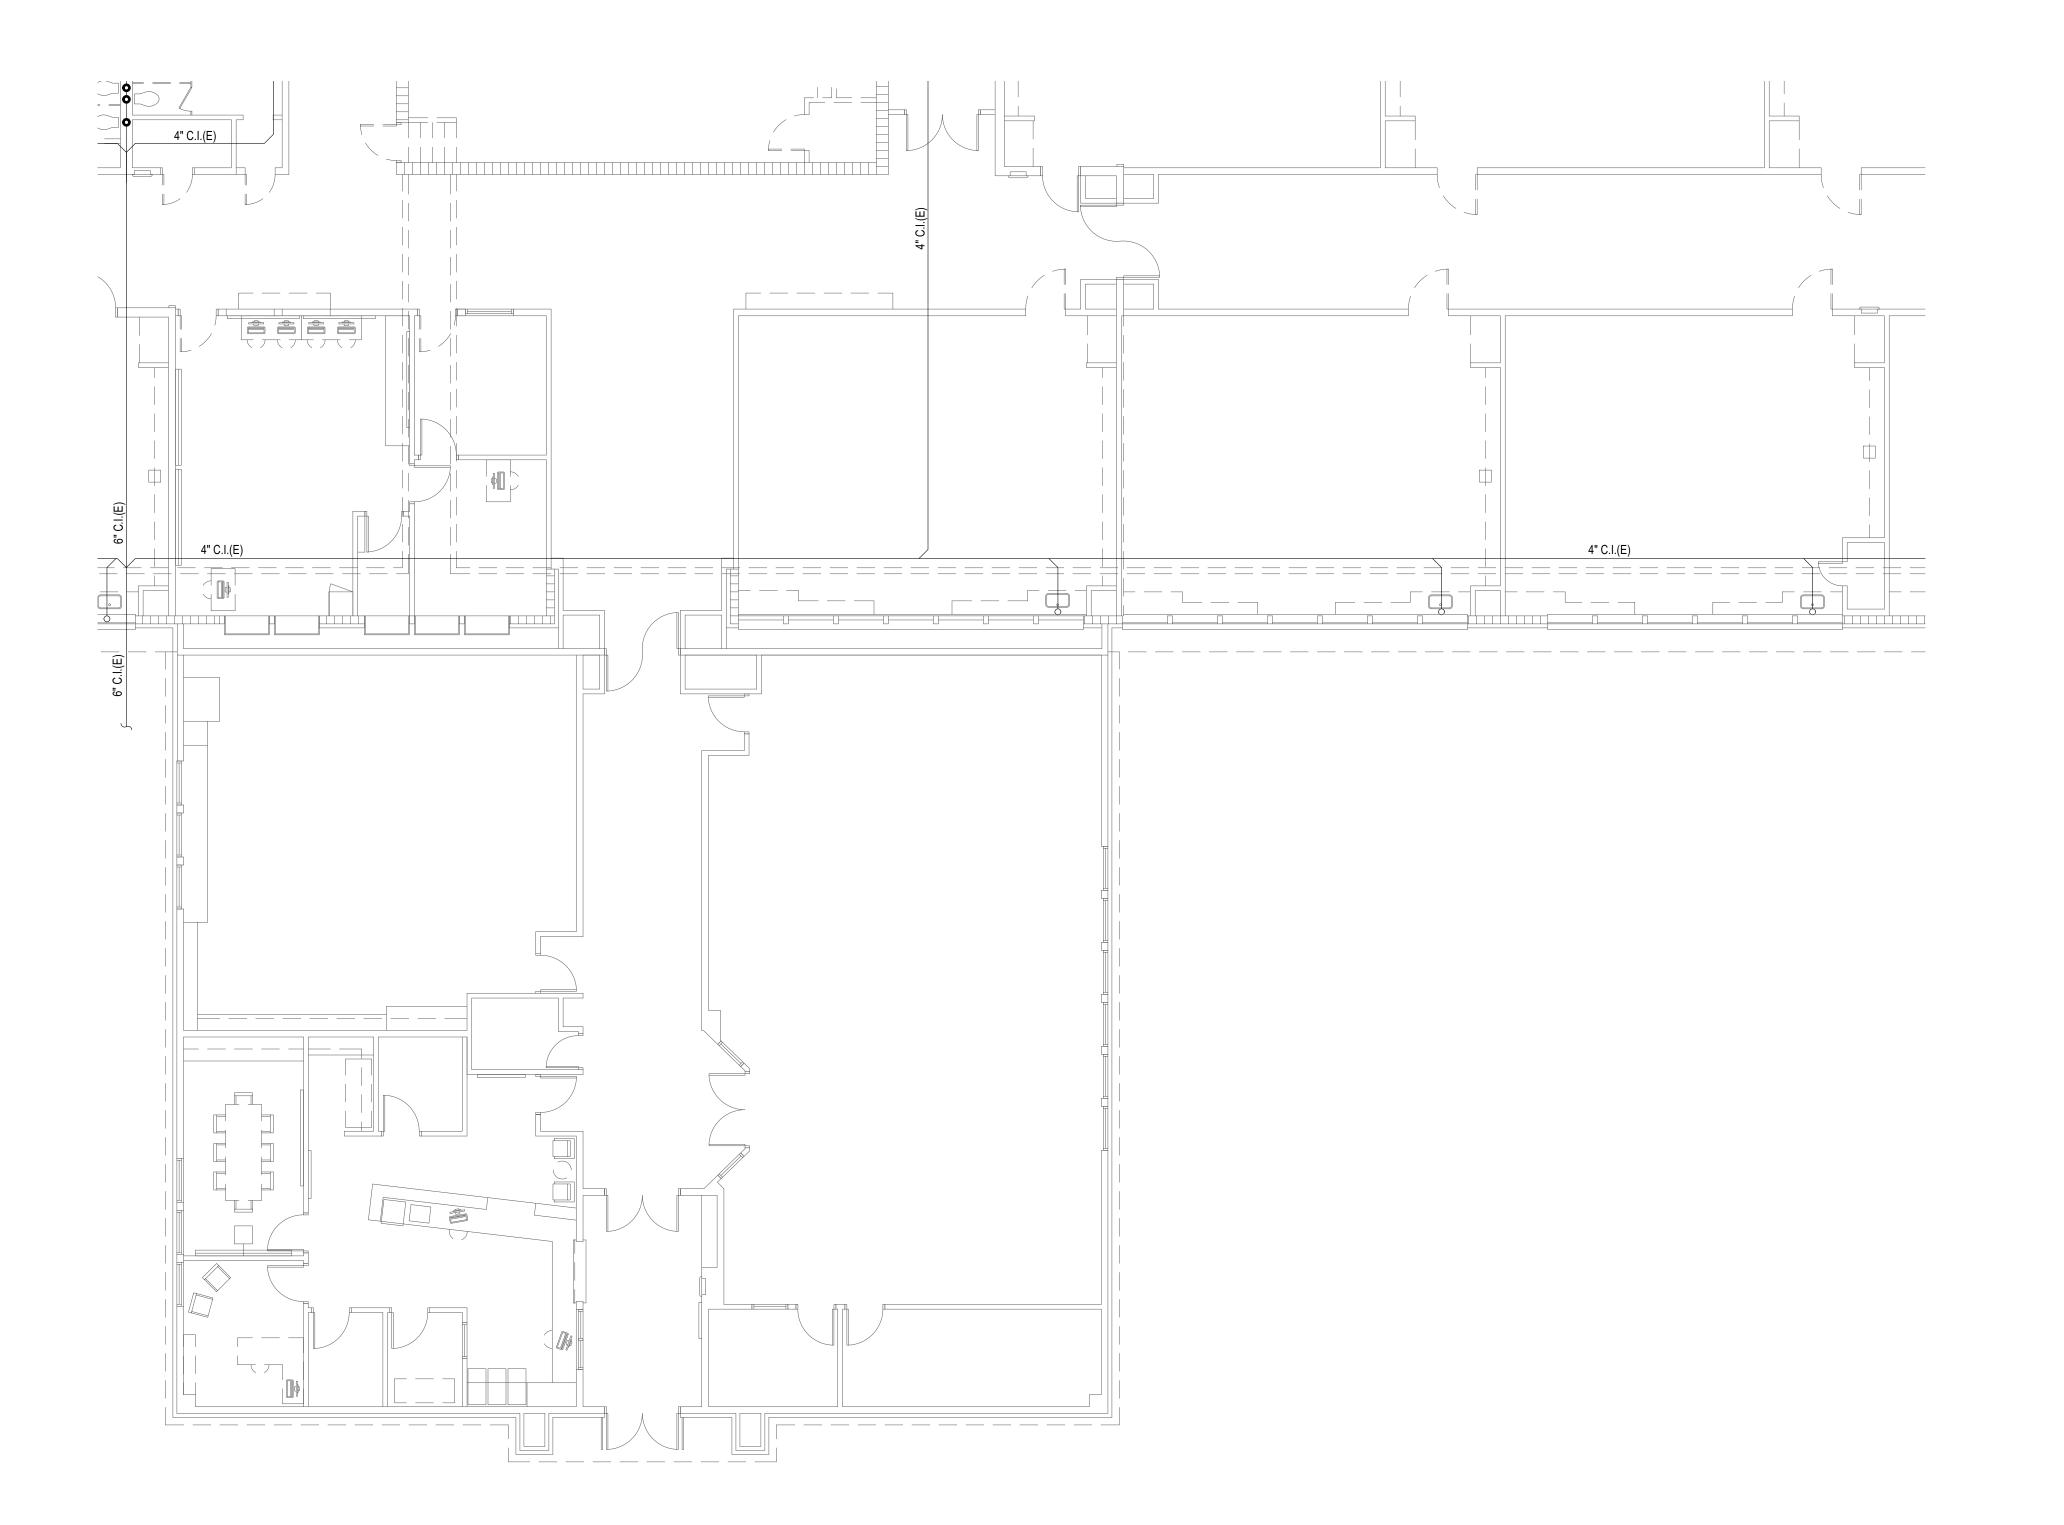
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Design Development

P-1.4





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1. KEYNOTES



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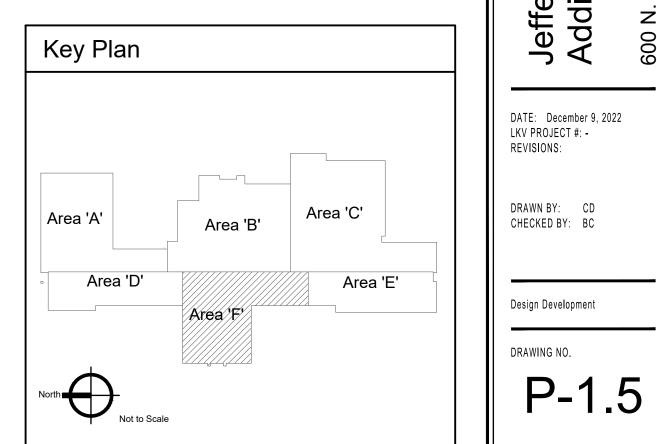


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Jefferson Elementary School Addition and Remodel 600 N. Fillmore Street,



# SYMBOL USED FOR NOTE CALLOUT.

1. KEYNOTES

Area 'A'

Area 'D'

North Not to Scale

Area 'B'

Area'E'



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Project No. 22-104





Jefferson Elementary School Addition and Remodel


DATE: December 9, 2022 LKV PROJECT #: -REVISIONS:

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Design Development



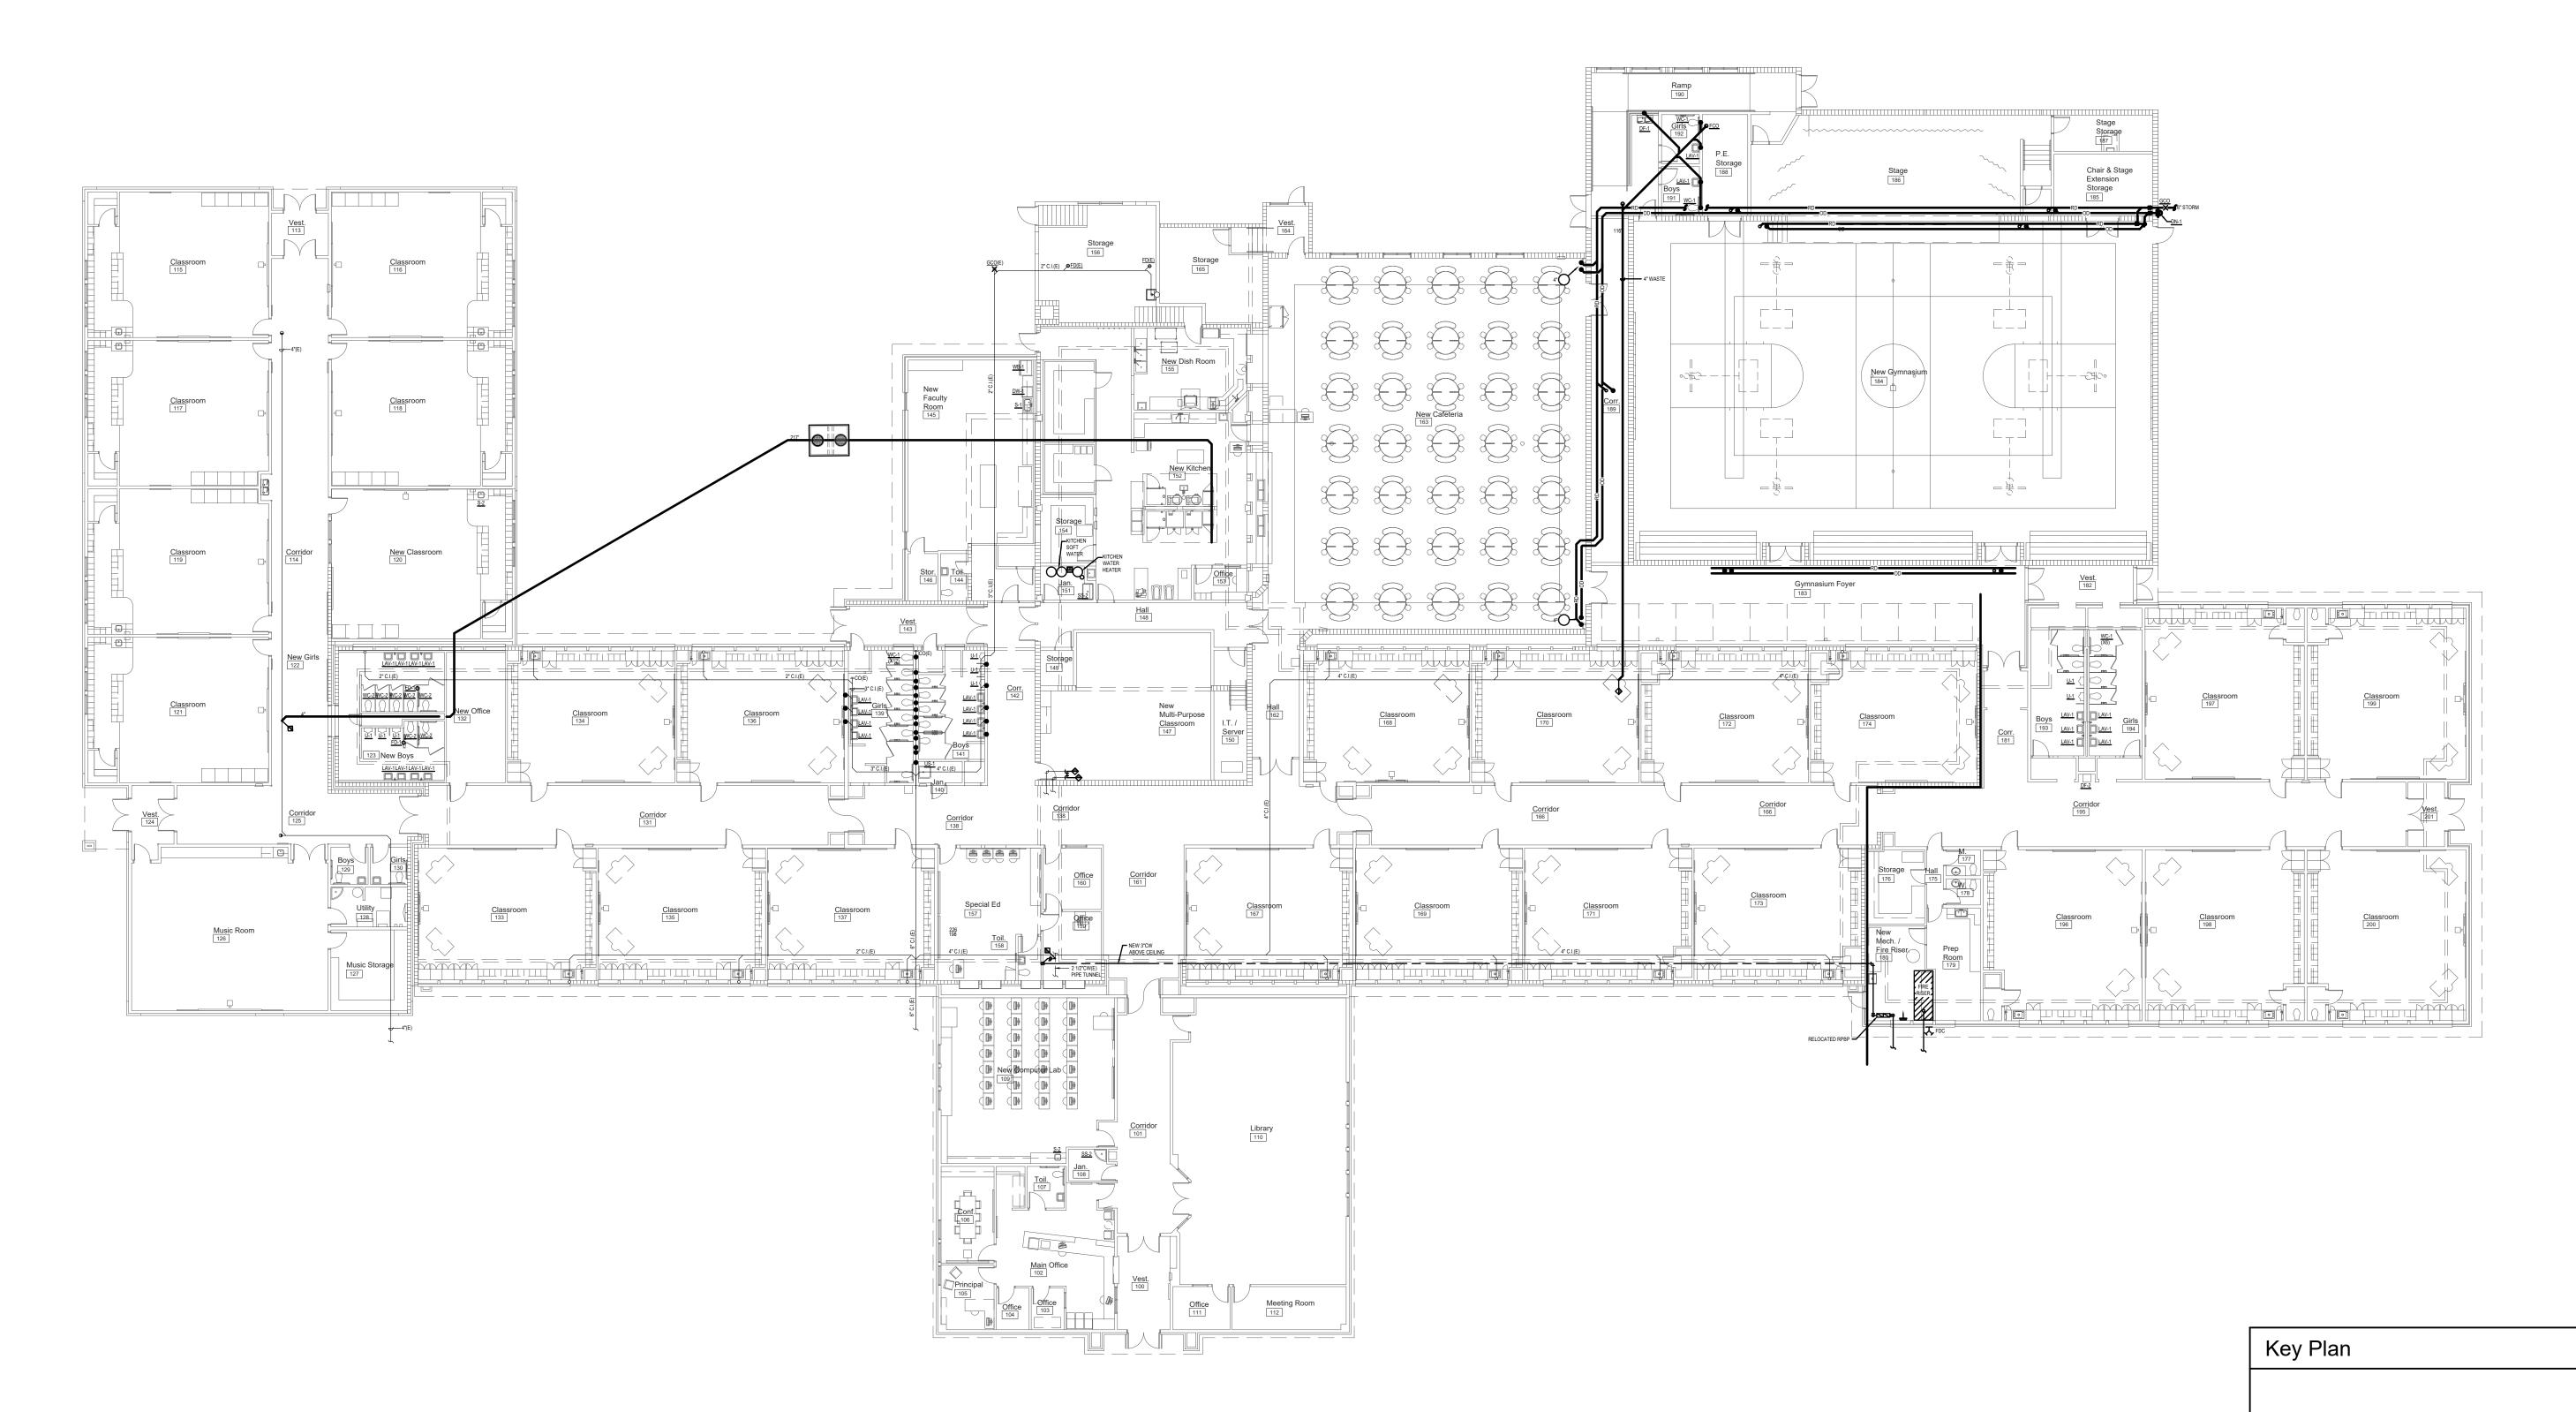

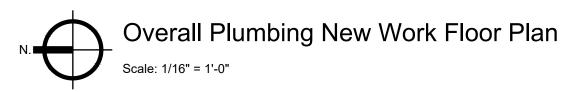

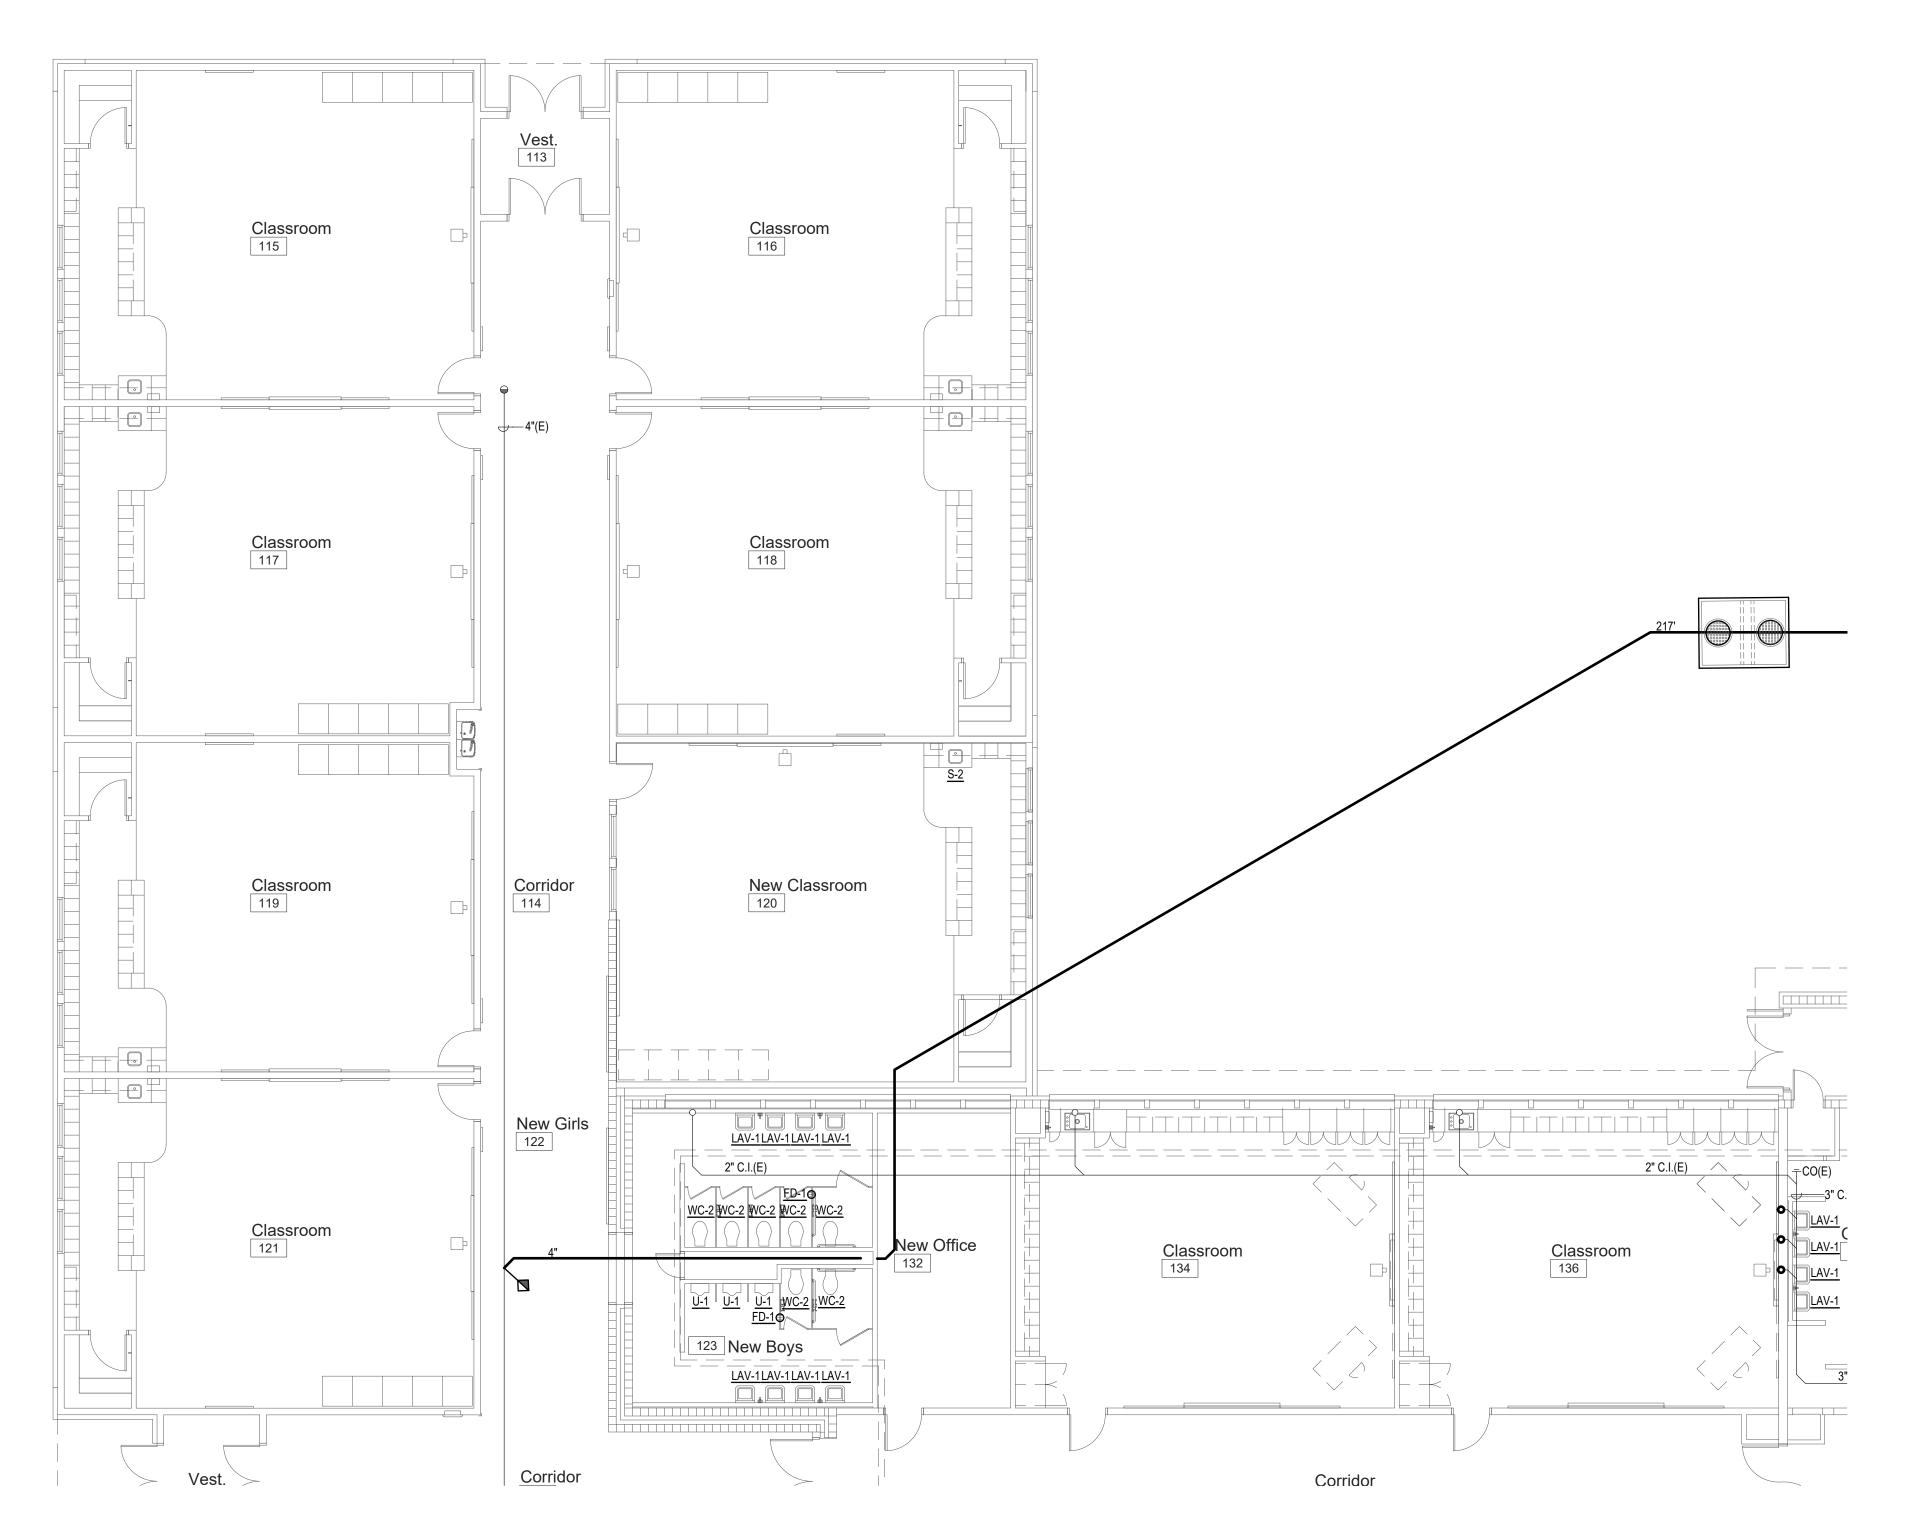Plumbing New Work Plan - Area 'A'

Scale: 1/8" = 1'-0"

# SYMBOL USED FOR NOTE CALLOUT.

1. KEYNOTES



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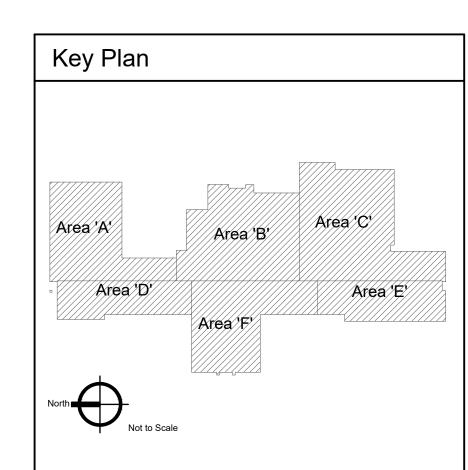
OVER 40 YEARS OF EXCELLENCE
Project No. 22-104



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> Jefferson Elementary School Addition and Remodel

600 N. Fillmore Street,




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Design Development

DRAWING NO.



Plumbing New Work Plan - Area 'B'
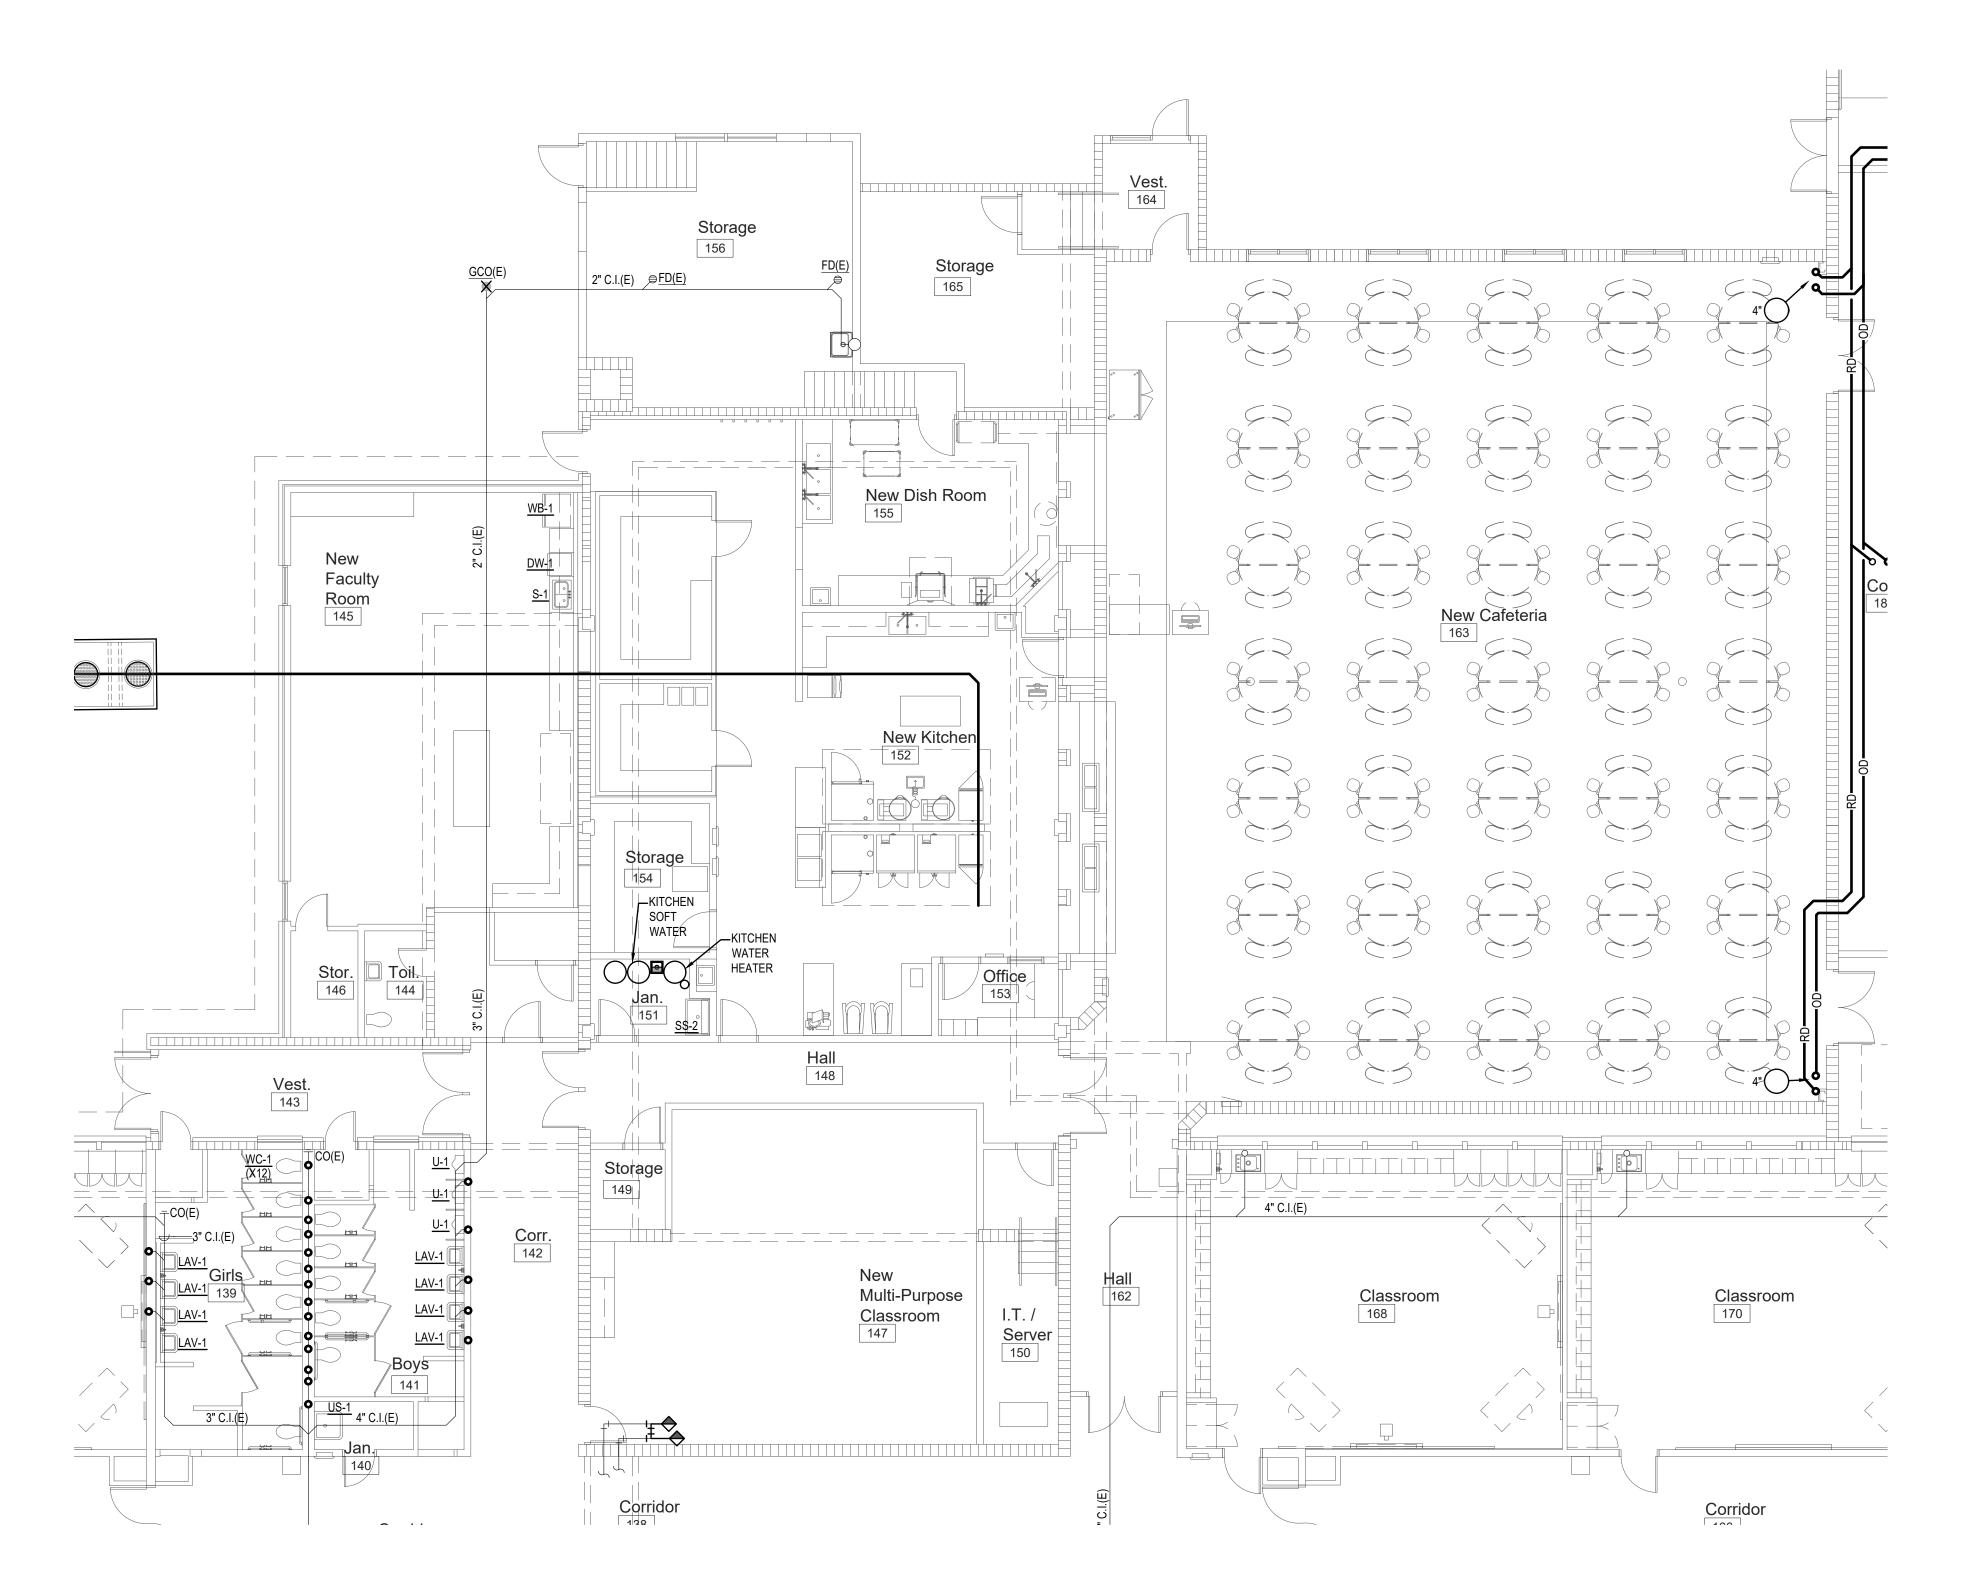
# SYMBOL USED FOR NOTE CALLOUT.

1. KEYNOTES



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Key Plan DATE: December 9, 2022 LKV PROJECT #: -REVISIONS: DRAWN BY: CD CHECKED BY: BC Area 'B' Area 'D' Area'E' Design Development DRAWING NO. North Not to Scale P-2.2

Area'A'

Plumbing New Work Plan - Area 'C'

### KEYED NOTES:

# SYMBOL USED FOR NOTE CALLOUT.

1. KEYNOTES



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Design Development

DRAWING NO.

P-2.3


Key Plan

Area'A'


Area'B'

Area'E'

Area'E'

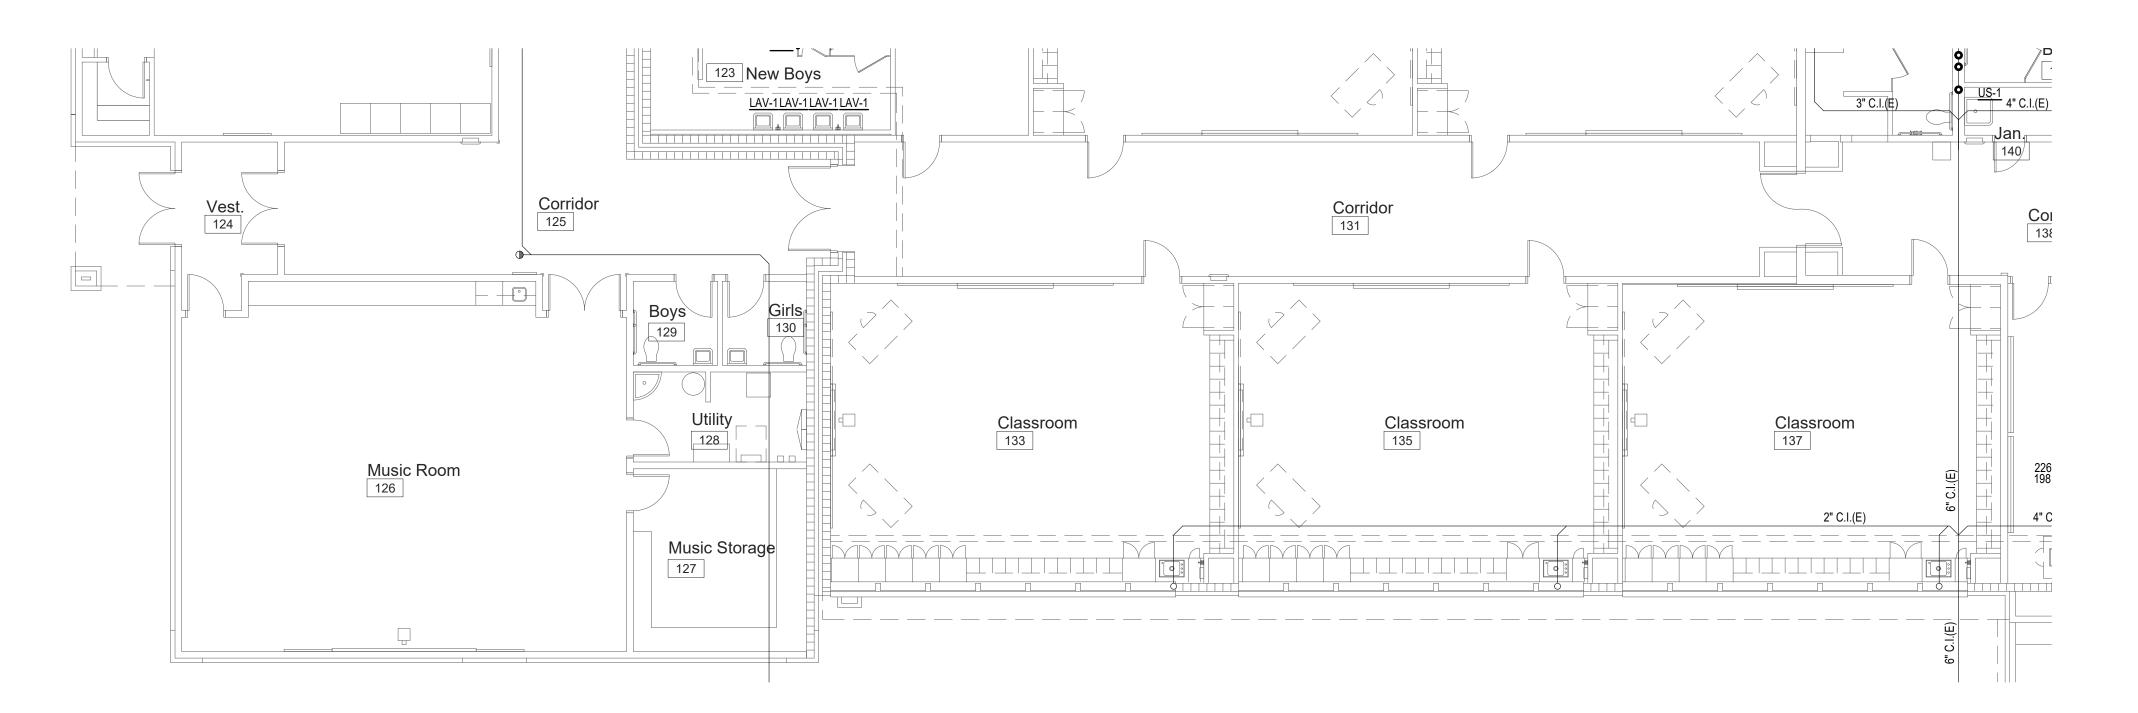



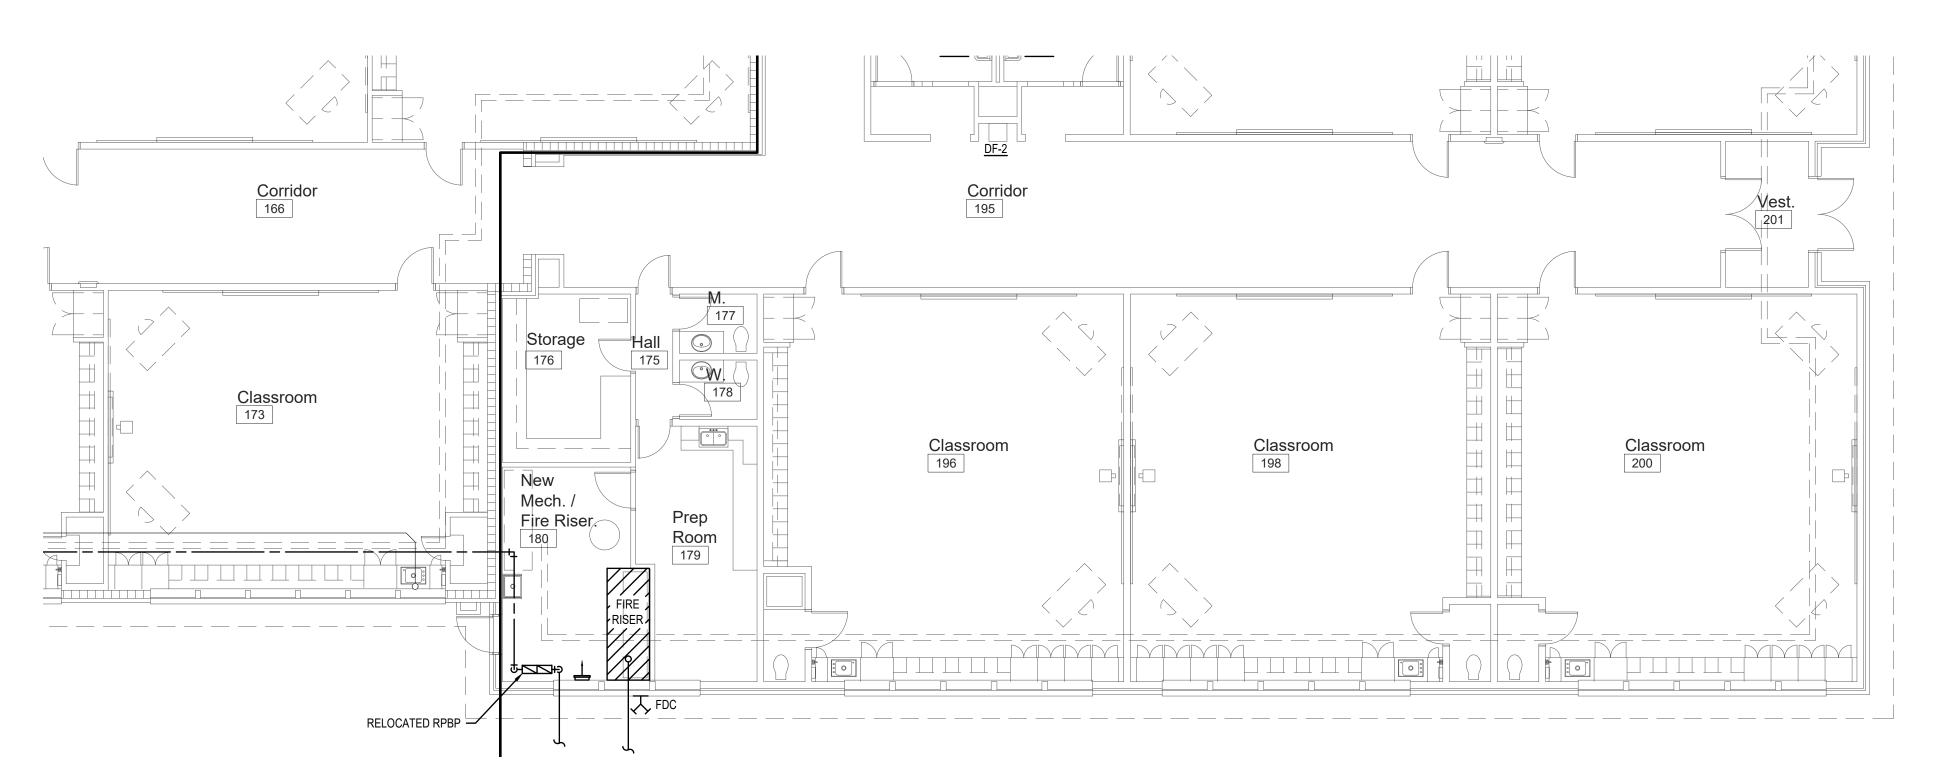

Plumbing New Work Plan - Area 'E'

Scale: 1/8" = 1'-0"

## **KEYED NOTES:**

# SYMBOL USED FOR NOTE CALLOUT.

1. KEYNOTES

Key Plan

Area 'A'

Area 'D'

North Not to Scale

Area 'B'

Area'E'



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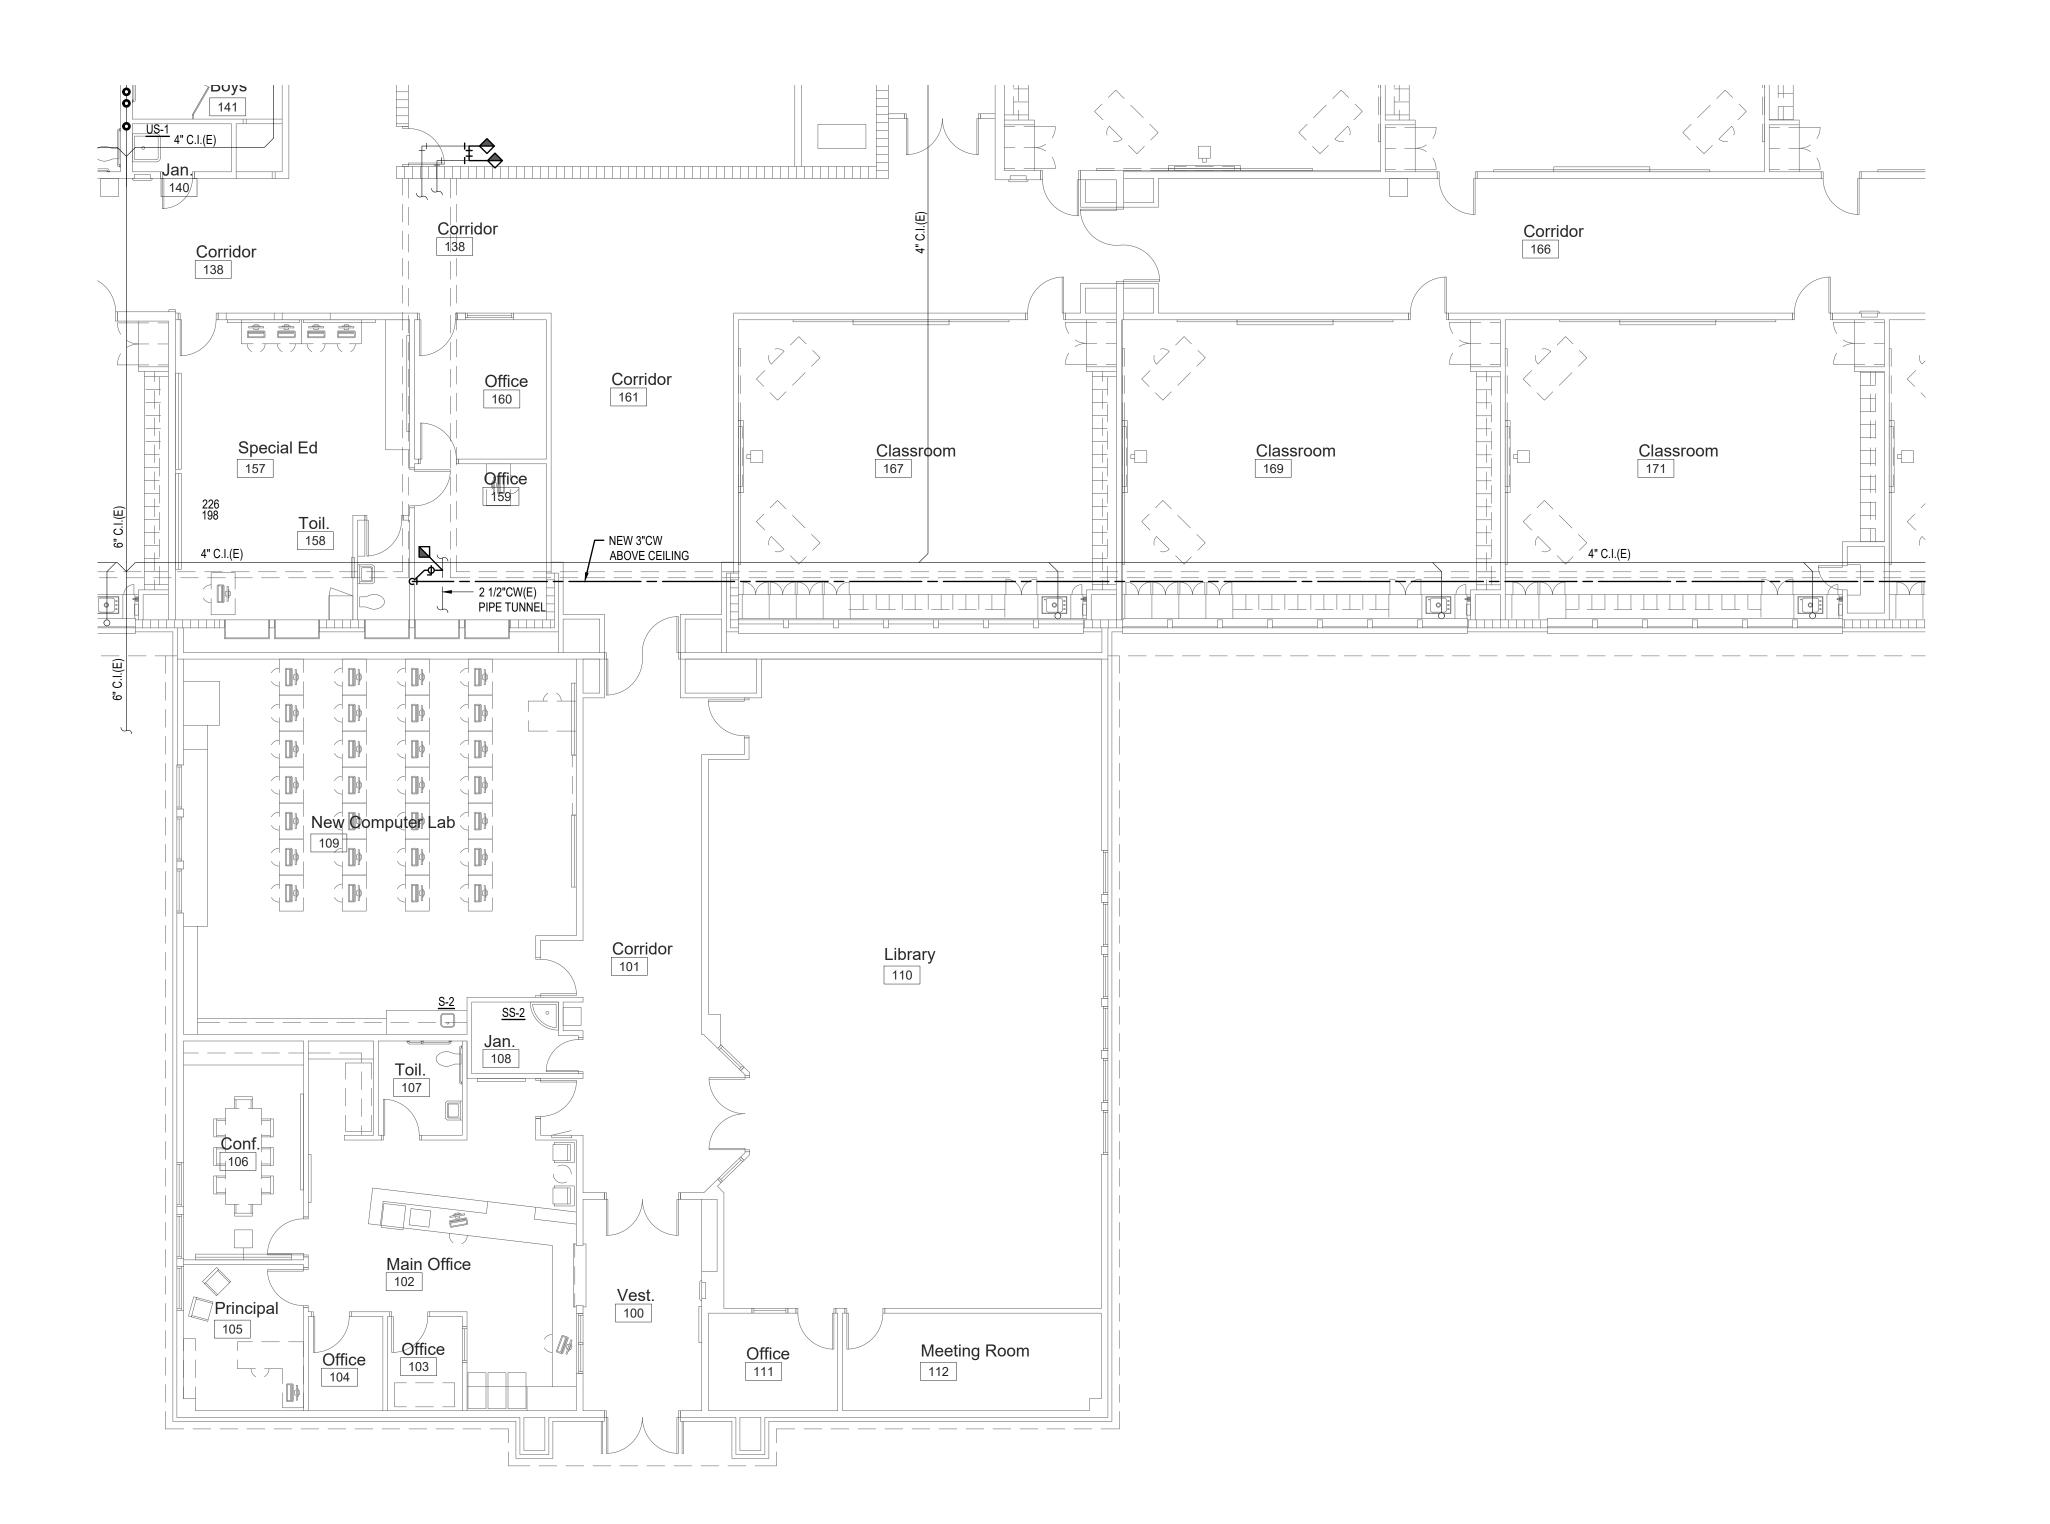
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# SYMBOL USED FOR NOTE CALLOUT.

1. KEYNOTES



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P-2.5

600 N. Fillmore Street,

Key Plan DATE: December 9, 2022 LKV PROJECT #: -REVISIONS: DRAWN BY: CD CHECKED BY: BC Area 'B' Area 'D' Area'E' Design Development DRAWING NO.

Area'A'

North Not to Scale

# SYMBOL USED FOR NOTE CALLOUT.

1. KEYNOTES



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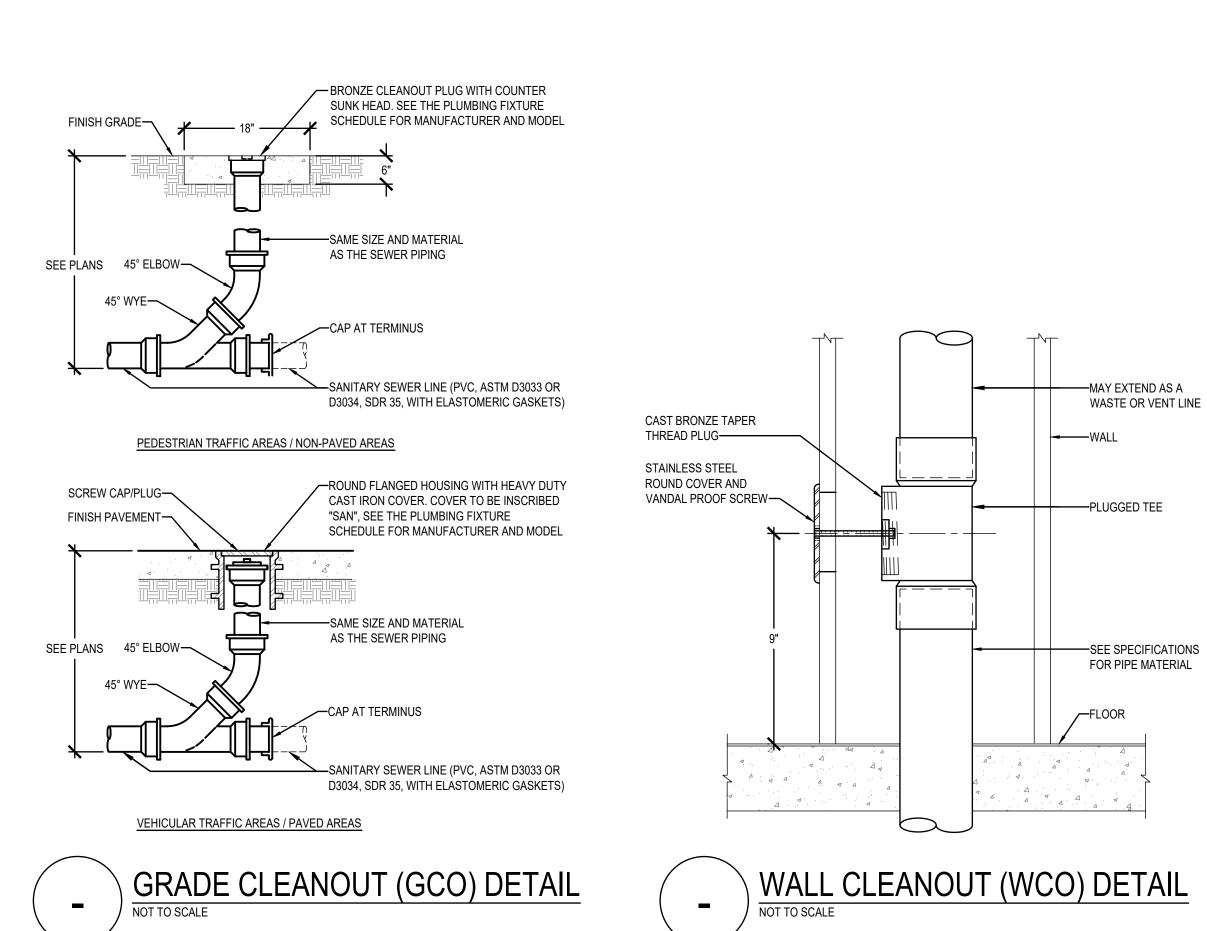
Jefferson Elementary School Addition and Remodel


DATE: December 9, 2022 LKV PROJECT #: -REVISIONS:

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Design Development

DRAWING NO.



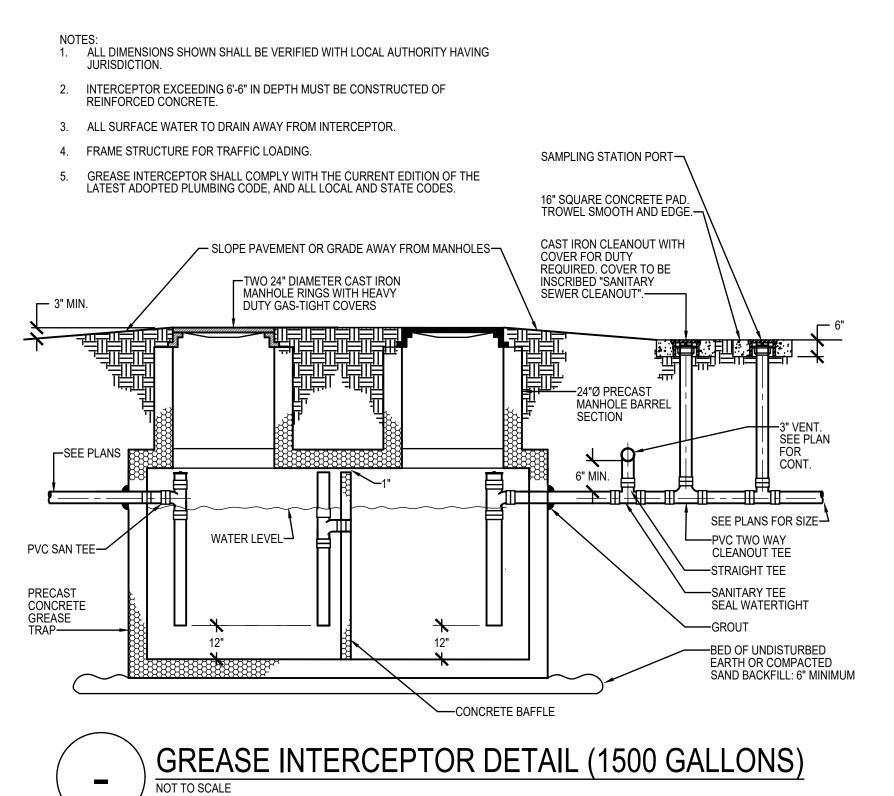

CLEANOUT AND ACCESS COVER. TOP OF

SPECIFICATIONS FOR PIPE MATERIAL

─BALANCE OF PIPING, SEE

 CLEANOUTS SHALL BE PROVIDED AT EACH HORIZONTAL DRAINAGE PIPE AT ITS UPPER TERMINAL, AND EACH RUN OF PIPING WHICH IS MORE THAN 100 FEET, AND SHALL BE

PIPING. AN ADDITIONAL CLEANOUT SHALL BE PROVIDED FOR EACH AGGREGATE HORIZONTAL CHANGE OF DIRECTION EXCEEDING ONE HUNDRED THIRTY-FIVE DEGREES,

PROVIDED FOR EACH 100 FEET DEVELOPED LENGTH, OR FRACTION THEREOF OF SUCH

PER APPLICABLE PLUMBING CODE. THIS SHALL BE PROVIDED REGARDLESS OF WHAT IS


FLOOR CLEANOUT (FCO) DETAIL

COVER TO BE FLUSH WITH TIP OF FLOOR

FLOOR LINE—

1/8 C.I.BEND-

SHOWN ON THE DRAWINGS.

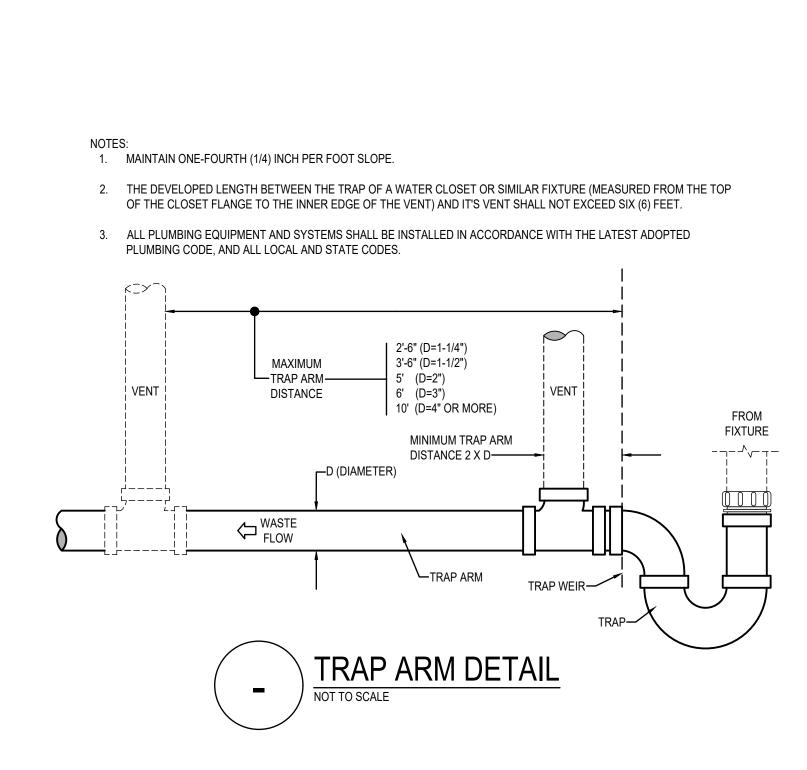



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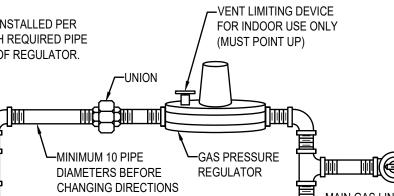
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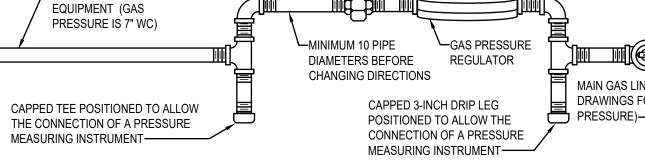
P-4.0




- 1. VENT REGULATORS PER MANUFACTURER'S AND LOCAL GAS COMPANY'S REQUIREMENTS.
- 5. A VENT LINE PROTECTOR MAY BE USED IN OUTDOOR APPLICATIONS TO PREVENT ENTRY OF WATER, INSECTS OR OTHER FOREIGN
- 6. VENT MUST BE PIPED A MINIMUM 3 FEET ABOVE OR 10 FEET AWAY









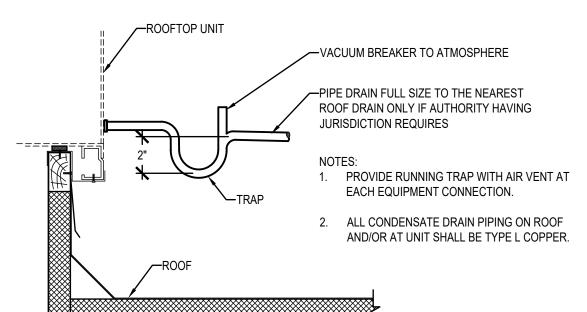


APPROVED PIPE SUPPORT SYSTEMS:

 MIRO MODEL 1.5 WITH SPACERS ADVANCED SUPPORT PRODUCTS VERSABLOCK BY FREEDOM INC.

PIPE SUPPORT REQUIREMENTS						
SIZE OF PIPE	SUPPORT REQUIRED					
1/2"	6' O.C.					
3/4" - 1"	8' O.C.					
1-1/4" OR LARGER	10' O.C.					

ROOFTOP UNIT - CONDENSATE DRAIN DETAIL

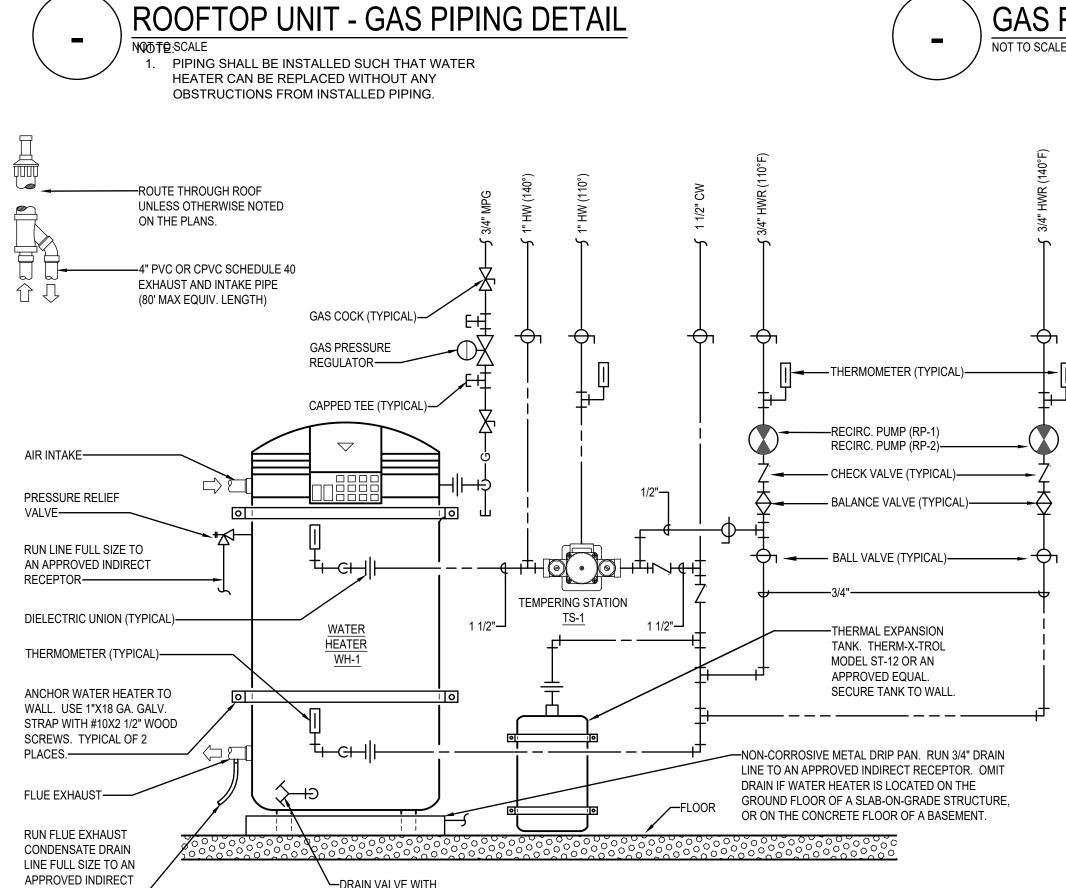

1. INSTALL FLEX CONNECTION AT ALL ROOF TOP UNITS WHICH HAVE SPRING ISOLATION CURBS (36" MAXIMUM).

2. INSTALL SOLID PIPE CONNECTION TO ALL ROOF TOP UNITS WHICH DO NOT HAVE SPRING ISOLATION CURBS.

3. PAINT PIPE WITH RUST RESISTANT PRIMER, RED OR GRAY. SHERWIN WILLIAMS PRO INDUSTRIAL DTM OR

-PROVIDE GALVANIZED

/-INSTALL GAS COCK

WITHIN 36" OF UNIT

ABOVE ROOF STRUCTURE

PIPE SUPPORT REQUIREMENTS

SUPPORT ALL GAS PIPING 6" MINIMUM

SUPPORT REQUIRED

6' O.C.

8' O.C.

10' O.C.

STEEL PIPE STRAP

SIZE OF PIPE

1/2"

3/4" - 1"

1-1/4" OR LARGER

APPROVED EQUAL.

APPROVED PIPE SUPPORT SYSTEMS:

MIRO MODEL 1.5 WITH SPACERS

ADVANCED SUPPORT PRODUCTS

VERSABLOCK BY FREEDOM INC

RECEPTOR.——

HIGH EFFICIENCY WATER HEATER & TEMPERING STATION PIPNG DETAIL NOT TO SCALE

─DRAIN VALVE WITH

THREADED HOSE CONNECTION

School Elementary Sand Remodel and Jefferson Addition a

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12/9/2022

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Boise, Idaho 83709

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2. DO NOT REDUCE THE VENT PIPE SIZE FROM THE REGULATOR.

3. TO LIMIT THE CONSEQUENCES OF RAIN, SNOW OR DEBRIS GETTING INTO THE VENT, ALWAYS TURN THE OUTLET OF THE VENT DOWN AND ABOVE POTENTIAL WATER OR SNOW LINES.

PROVIDE A BUG SCREEN ON THE VENT OUTLET TO DETER INSECTS FROM NESTING IN THE LINE. NEVER PAINT OVER THE BUG SCREEN.

MATERIALS THAT COULD CAUSE BLOCKAGE.

FROM ALL FRESH AIR INTAKES.

7. VENTS SHALL RUN INDEPENDENTLY TO THE OUTDOORS AND SHALL SERVE ONLY A SINGLE DEVICE VENT.

8. REGULATOR VENT PIPING SHALL NOT EXCEED THE LENGTH

SPECIFIED IN THE REGULATOR MANUFACTURER'S INSTRUCTIONS.

—GAS LINE TO

GAS COCK (TYPICAL)

MAIN GAS LINE (SEE DRAWINGS FOR GAS PRESSURE)——

REGULATOR VENT

			CO	NNECTION S	IZE		
SYMBOL	FIXTURE DESCRIPTION	WASTE	VENT	TRAP	CW	HW	MANUFACTURER / MODEL NUMBER / DESCRIPTION / ADDITIONAL COMMENTS
<u>DF-1</u>	DRINKING FOUNTAIN WITH BOTTLE FILLING STATION (INTERIOR DUAL BUBBLERS) (ELECTRIC WATER COOLER) (ADA COMPLIANT) (HIGH/LOW)	1 1/2	1 1/2	1 1/2	1/2		ELKAY MODEL LZSTL8WSLP (FILTERED) MODEL EZSTL8WSVRSK (NON-FILTERED) BI-LEVEL ADA COOLER WITH BOTTLE FILLING STATION FURNISHED WITH FLEXI-GUARD SAFETY BUBBLER. BUBBLER ACTIVATED BY PUSHBAR. BOTTLE FILLER ACTIVATED BY ELECTRONIC SENSOR WITH AUTOMATIC 30-SECOND SHUT-OFF TIMER. 115 VOLT, 5.0 AMPS, 60 HERTZ. PROVIDE WITH JAY R. SMITH 0834 FLOOR MOUNTED SUPPORT CARRIER. OPTION - CANE APRON TO BE INSTALLED ON HIGH COOLER.
DF-2	DRINKING FOUNTAIN WITH BOTTLE FILLING STATION (INTERIOR SINGLE BUBBLER) (ELECTRIC WATER COOLER) (ADA COMPLIANT)	1 1/2	1 1/2	1 1/2	1/2		ELKAY MODEL LZS8WSLP (FILTERED) MODEL EZSG8WSLK (NON-FILTERED) SINGLE ADA COOLER WITH BOTTLE FILLING STATION FURNISHED WITH FLEXI-GUARD SAFETY BUBBLER. BUBBLER ACTIVATED BY PUSHBAR. BOTTLE FILLER ACTIVATED BY ELECTRONIC SENSOR WITH AUTOMATIC 30-SECOND SHUT-OFF TIMER. 115 VOLT, 5.0 AMPS, 60 HERTZ. PROVIDE WITH JAY R. SMITH 0830 FLOOR MOUNTED SUPPORT CARRIER. OPTION - CANE APRON.
<u>DN-1</u>	DOWN SPOUT NOZZLE (CAST IRON)	SEE PLANS					JAY R. SMITH FIGURE NUMBER 1770-NB CAST IRON NOZZLE WITH WALL FLANGE, NICKEL-BRONZE FINISH.
<u>ET-1</u>	EXPANSION TANK				3/4		AMTROL THERM-X-TROL ST-12, OR APPROVED EQUAL, NON-ASME SERIES THERMAL EXPANSION ABSORBER, ANTI-MICROBIAL LINER, AND 5 YEAR WARRANTY.
EYE-1	EMERGENCY EYE WASH (WALL MOUNTED w/ RECOIL HOSE) (USED WITH SERVICE SINK)				1/2	1/2	ACORN SAFETY MODEL S0406-CH12-BFP, WALL MOUNTED WITH DUAL 45° ANGLED HEADS AND RECOIL HOSE, PROVIDE WITH FLIP TOP DUST COVERS, UNIVERSAL EMERGENCY SIGN, DOUBLE CHECK VALVE, STAINLESS STEEL 90° WITH SHEET NIPPLE, AND ACORN MODEL ET71-1-BVS-OTG LEAD-FREE EMERGENCY THERMOSTATIC MIXING VALVE WITH 1/2" NPT INLETS & OUTLET, 4 GPM @ 5 PSID. PROVIDE WITH LOCKABLE INLET BALL VALVES, STANDARD OUTLET TEMPERATURE GAUGE, AND SELECTABLE TEMPERATURE RANGE FROM 60°F TO 95°F.
<u>FD-1</u>	FLOOR DRAIN (PVC BODY) (CONCRETE FLOOR)	2	2	2			SIOUX CHIEF SERIES NUMBER 832-2PNR, POST- CONSTRUCTION LEVELING FLOOR DRAIN, NO-HUB OUTLET, 6-1/2" ROUND, ADJUSTABLE NICKEL BRONZE STRAINER AND TRAP PRIMER PORT. INSTALL TOP OF DRAIN 1/8" BELOW FINISH FLOOR AND CAULK EDGE.
<u>FS-1</u>	FLOOR SINK (6" DEEP) (HALF GRATE, FOOT TRAFFIC RATED)	2	2	2			JAY R. SMITH FIGURE NUMBER 3100Y-12, CAST IRON RECEPTOR, ALUMINUM DOME STRAINER, NICKEL BRONZE GRATE, AND TRAP PRIMER. INSTALL TOP OF SINK 1/8" BELOW FINISH FLOOR AND CAULK EDGE.
<u>FS-2</u>	FLOOR SINK (10" DEEP) (HALF GRATE, FOOT TRAFFIC RATED)	4	2	4			JAY R. SMITH FIGURE NUMBER 3160Y-12, CAST IRON RECEPTOR, ALUMINUM DOME STRAINER, NICKEL BRONZE GRATE, AND TRAP PRIMER. INSTALL TOP OF SINK 1/8" BELOW FINISH FLOOR AND CAULK EDGE.
<u>FS-3</u>	FLOOR SINK (6" DEEP) (HALF GRATE, FOOT TRAFFIC RATED) COMMERCIAL KITCHEN, BAR, OR PROCESSING LOCATIONS	2	2	2			JAY R. SMITH FIGURE NUMBER 3002Y-12, STAINLESS STEEL RECEPTOR, DOME STRAINER AND GRATE WITH TRAP PRIMER. INSTALL TOP OF SINK 1/8" BELOW FINISH FLOOR AND CAULK EDGE.
<u>FS-4</u>	FLOOR SINK (10" DEEP) (HALF GRATE, FOOT TRAFFIC RATED) COMMERCIAL KITCHEN, BAR, OR PROCESSING LOCATIONS	4	2	4			JAY R. SMITH FIGURE NUMBER 3004Y-12, STAINLESS STEEL RECEPTOR, DOME STRAINER AND GRATE WITH TRAP PRIMER. INSTALL TOP OF SINK 1/8" BELOW FINISH FLOOR AND CAULK EDGE.
<u>GCO</u>	GRADE CLEANOUT (NON-PAVED AREAS)	SEE PLANS					JAY R. SMITH 4220 SERIES, ROUND EXTRA HEAVY DUTY CAST IRON TOP. FURNISH WITH WITH ABS PLUG. COVER TO BE INSCRIBED "SAN".
<u>GCO</u>	GRADE CLEANOUT (PAVED AREAS) (VEHICULAR TRAFFIC)	SEE PLANS					JAY R. SMITH 4250 SERIES, ROUND FLANGED HOUSING WITH HEAVY DUTY CAST IRON COVER. FURNISH WITH ABS PLUG. COVER TO BE INSCRIBED "SAN".
<u>GI-1</u>	GREASE INTERCEPTOR (1500 GALLONS)	4	3				PRE-CAST CONCRETE, 1500 GALLON CAPACITY, GREASE INTERCEPTOR. SEE DRAWING FOR DETAILS. NO SPLIT DESIGN VAULTS WITH GASKETS BELOW FLUID LEVEL ALLOWED.
<u>HB-1</u>	HOSE BIBB (EXTERIOR) (NON-FREEZE)				3/4		WOODFORD MODEL 67 - EXPOSED STYLE WITH MODEL 50HA BACKFLOW PREVENTER, 3/4" INLET, AND CHROME PLATED. PROVIDE WITH TEE KEY AND INSTALL AT 18" ABOVE FINISH GRADE.
LAV-6	MOTION SENSOR LAVATORY (WALL MOUNTED) (BATTERY OPERATED) (ADA COMPLIANT)	1 1/2	1 1/2	1 1/4	1/2	1/2	KOHLER KINGSTON MODEL K-2005, WITH GRID STRAINER, SLOAN OPTIMA PLUS MODEL EAF-350 BATTERY POWERED FAUCET WITH 4" TRIM PLATE AND WATTS SERIES LFUSG-B LEAD-FREE, THERMOSTATIC MIXING VALVE, ASSE STANDARD 1070 LISTED, BRONZE BODY, INTEGRAL CHECK VALVES, AND SELECTABLE TEMPERATURE RANGE FROM 80°F TO 120°F. PROVIDE WITH JAY R. SMITH FIGURE NUMBER 0700-Z SUPPORT WITH CONCEALED ARMS. PROVIDE WITH LS-1 LAV SHIELD.
<u>LS-1</u>	LAVATORY SHIELD (WALL MOUNTED SHIELD FOR CONCEALING PIPING, VALVES, AND INSTANTANEOUS WATER HEATERS)	-	ŀ	ı			TRUEBRO "LAV SHIELD" ADA COMPLIANT, TOTAL ENCLOSURE. SINGLE-PIECE CONSTRUCTION, SLOAN OPTISHIELD ETF-529, OR APPROVED EQUAL.
<u>OD-1</u>	OVERFLOW ROOF DRAIN (METAL GRATE)	SEE PLANS					JAY R. SMITH FIGURE NUMBER 1070Y GENERAL PURPOSE DRAIN WITH LOW PROFILE DOME. PROVIDE WITH SUMP RECEIVER, UNDERDECK CLAMP, CAST IRON DOME, INTERNAL DAM STANDPIPE, AND RAIN SHIELD.
<u>RD-1</u>	ROOF DRAIN (LOW PROFILE DOME STYLE) (METAL GRATE)	SEE PLANS					JAY R. SMITH FIGURE NUMBER 1010Y GENERAL PURPOSE DRAIN WITH LOW PROFILE DOME. PROVIDE WITH SUMP RECEIVER, UNDERDECK CLAMP, AND CAST IRON DOME.
<u>RH-1</u>	ROOF HYDRANT (NON-FREEZE) (DRAIN LINE REQUIRED) (MUSGROVE STANDARD)	-	1		1		WOODFORD MODEL RHY2-MS NON-FREEZE STYLE ROOF HYDRANT WITH 3/4" HOSE CONNECTION AND INTEGRAL DOUBLE CHECK BACKFLOW PREVENTER. REQUIRES 1/8" DRAIN LINE PIPED TO APPROVED INTERCEPTOR. (SUEZ IS REQUIRING THAT ROOF HYDRANTS ARE PROVIDED WITH A REDUCED PRESSURE BACKFLOW PREVENTER)
<u>RP-1</u>	RECIRCULATION PUMP (HOT WATER RETURN SYSTEM) (MEDIUM SIZED SYSTEM)					3/4	BELL AND GOSSETT BRONZE MODEL NBF-22, 115 VOLT, 0.8 AMPS, 92 WATTS, AND SHALL PROVIDE 7 GPM AT 10 FEET HEAD. INCLUDE 7-DAY PROGRAMMABLE ELECTRONIC TIME CLOCK WITH BATTERY BACKUP, INTERMATIC MODEL GM40AVE-RD89. APPROVED ALTERNATE: ARMSTRONG, TACO, GRUNDFOS.
<u>S-2</u>	SINK - DOUBLE COMPARTMENT (14" X 14" X 6 1/2" - EACH) (ADA COMPLIANT)	2	1 1/2	1 1/2	1/2	1/2	ELKAY LUSTERTONE MODEL LRAD331965: 6-1/2" DEEP, STAINLESS STEEL SINK. PROVIDE AND INSTALL ELKAY MODEL LK3001CR SINGLE LEVER CHROME FAUCET WITH SWING SPOUT AND HOSE SPRAY, ELKAY MODEL LK35 STAINLESS STEEL STRAINER BASKET AND TAILPIECE, AND WATTS SERIES LFUSG-B LEAD-FREE, THERMOSTATIC MIXING VALVE, ASSE STANDARD 1070 LISTED, BRONZE BODY, INTEGRAL CHECK VALVES, AND SELECTABLE TEMPERATURE RANGE FROM 80°F TO 120°F.
<u>S-2</u>	SINK - SINGLE COMPARTMENT WITH BUBBLER (CLASSROOM / ADA COMPLIANT)	2	1 1/2	1 1/2	1/2	1/2	JUST CLASSROOM SINK # CRA-ADA-1725-A-GR (6 1/2" DEEP WITH JTR-51-R70-VR DOUBLE HANDLE FAUCET, JSB-10-VR-FLX BUBBLER, J-ADA-35 DRAIN, BRASS P-TRAP, AND ANGLE SUPPLY STOPS. AND WATTS SERIES LFUSG-B LEAD-FREE, THERMOSTATIC MIXING VALVE, ASSE STANDARD 1070 LISTED, BRONZE BODY, INTEGRAL CHECK VALVES, AND SELECTABLE TEMPERATURE RANGE FROM 80°F TO 120°F.
<u>SS-1</u>	SERVICE SINK (36" X 24" X 10") (FLOOR MOUNTED)	3	2	3	1/2	1/2	ACORN TERRAZZO-WARE MODEL TRH-242410: PROVIDE AND INSTALL WITH MODEL KFC CHROME UTILITY FAUCET, STAINLESS STEEL BUMPER GUARD, DRAIN GASKET, 36" HOSE AND WALL HANGER, MOP HANGER, AND (2) STAINLESS STEEL WALL GUARDS. MOUNT FAUCET 36" AFF.
<u>SS-2</u>	SERVICE SINK (28" RADIUS CORNER X 12") (FLOOR MOUNTED)	3	2	3	1/2	1/2	ACORN TERRAZZO-WARE MODEL TCR-28: PROVIDE AND INSTALL WITH MODEL KFC CHROME UTILITY FAUCET, STAINLESS STEEL BUMPER GUARD, DRAIN GASKET, 36" HOSE AND WALL HANGER, MOP HANGER, AND (2) STAINLESS STEEL WALL GUARDS. MOUNT FAUCET 36" AFF.
<u>TP-1</u>	TRAP PRIMER (PRESSURE ACTIVATED) (1 TO 4 TRAPS)				1/2"		PRECISION PLUMBING PRODUCTS MODEL CPO-500 WITH DU DISTRIBUTION UNIT IF REQUIRED FOR SERVING MORE THAN ONE TRAP.
<u>TP-1</u>	TRAP PRIMER (FLUSH VALVE PRIMER) (1 TRAP)				1/2"		PRECISION PLUMBING PRODUCTS MODEL FVP-1VB WITH VACUUM BREAKER. TRAP PRIMER TUBING SHALL BE INSTALLED OFF BACK OF FLUSH VALVE.
<u>U-1</u>	URINAL (MOTION SENSOR / BATTERY OPERATED) (SEE ARCH FOR MOUNTING HEIGHT)	2	1 1/2	INT.	3/4		KOHLER BARDON MODEL K-4991-ET WALL MOUNTED URINAL WITH 3/4" TOP SPUD. SLOAN REGAL 186 SFSM-0.5 SIDE MOUNT OPERATOR WITH MANUAL OVERRIDE FLUSH BUTTON, 0.5 GPF. INCLUDE BEEHIVE STRAINER AND JAY R. SMITH FIGURE NUMBER 0637 ADJUSTABLE FIXTURE SUPPORT.

<u>US-1</u>	UTILITY SINK (23" X 21" X 13") (FLOOR MOUNTED)	2	1 1/2	1 1/2	1/2	1/2	FIAT MOLDED STONE MODEL FL-1 FLOOR MOUNTED SINK WITH EASY LEVELING LEGS, DRAIN ASSEMBLY AND STOPPER WITH FIAT A1 CHROME FAUCET, DECK MOUNTED, 4" O.C. WITH 4" WRISTBLADES, 6-3/4" SWING SPOUT, AND WATTS SERIES LFUSG-B LF, THERMOSTATIC MIXING VALVE, ASSE STANDARD 1070 LISTED, BRONZE BODY, INTEGRAL CHECK VALVES, AND SELECTABLE TEMPERATURE RANGE FROM 80°F TO 120°F.	
<u>WB-1</u>	WALL BOX (WATER SUPPLY TO ICE MAKER)				1/2		OATEY FIREMASTER MODEL 39121 WITH FACEPLATE AND ADJUSTABLE METAL SUPPORT BRACKETS. FIRE-RATED, LOW LEAD, OR APPROVED EQUAL.	
<u>WC-1</u>	WATER CLOSET (FLUSH VALVE) (FLOOR MOUNTED) (PUBLIC STANDARD)	4	2	INT.	1		KOHLER WELLCOMME MODEL K-96053 / FLOOR MOUNTED, WITH ELONGATED BOWL. KOHLER LUSTRA MODEL K-4666-C / ELONGATED OPEN FRONT SEAT WITH HINGE. SLOAN REGAL MODEL 111-1.6 FLUSHOMETER, 1.6 GPF.	
<u>WC-2</u>	WATER CLOSET (MOTION SENSOR / BATTERY OPERATED) (WALL MOUNTED) (SEE ARCHITECTURAL ELEVATIONS FOR MOUNTING HEIGHT)	4	2	INT.	1		KOHLER KINGSTON MODEL K-4325 WALL MOUNTED WITH ELONGATED BOWL. KOHLER LUSTRA MODEL K-4666-C ELONGATED OPEN FRONT SEAT WITH HINGE. SLOAN REGAL XL111-SFSM FLUSHOMETER. JAY R. SMITH FIGURE NUMBER 0211Y-M54 ADJUSTABLE FIXTURE SUPPORT WITH LEG KIT AND 8" NIPPLE.	
WCO	WALL CLEANOUT	SEE PLANS					JAY R. SMITH 4472T SERIES WITH CAST BRONZE TAPER THREAD PLUG, STAINLESS STEEL ROUND COVER, AND A STAINLESS STEEL VANDAL PROOF SCREW.	
<u>WH-9</u>	WATER HEATER (NOMINAL 100 GALLON) (NATURAL GAS - HIGH EFFICIENCY)				SEE PLANS	SEE PLANS	BRADFORD WHITE MODEL EF-100T-199E-3N. 199 MBH INPUT, 110V/1Ø, 1.8 AMPS, 28" DIAMETER, 78" TALL WITH SIDE CONNECTIONS. PROVIDE WITH PVC CONCENTRIC INTAKE/VENT KIT AND SEISMIC STRAP. PROVIDE WATER HEATER WITH HEAT TRAP.	

NOTES:

- 1. ALL ADA COMPLIANT FIXTURES MUST COMPLY WITH ICC/ANSI A117.1. SEE ARCHITECTURAL PLANS FOR HANDICAPPED FIXTURE DESIGNATIONS, LOCATIONS, CLEARANCES, AND MOUNTING HEIGHTS.
- 2. ALL EXPOSED HW PIPING, CW PIPING, AND DRAIN LINES BENEATH ALL LAVATORIES AND ALL ADA COMPLIANT SINKS MUST BE INSULATED TO PREVENT INJURY. REFER TO ARCHITECTURAL PLANS. INSULATE WITH MOLDED CLOSED CELL VINYL INSULATION TRUEBRO, PLUMBEREX, OR EQUAL.
- 3. PROVIDE P-TRAP PRIMERS FOR ALL FLOOR DRAINS AND FLOOR SINKS (TRAP PRIMERS ARE NOT INDICATED ON PLANS REFERENCE DETAILS AND SPECIFICATIONS FOR ADDITIONAL INFORMATION). PROVIDE A BALL TYPE SHUT-OFF VALVE UPSTREAM OF PRIMER VALVE. SEE SPECIFICATIONS.
- SEE SPECIFICATIONS FOR ALTERNATE APPROVED MANUFACTURERS.
   HIGH EFFICIENCY WATER HEATERS: PROVIDE WITH CONDENSATE NEUTRALIZATION KIT BY JJM BOILER WORKS MODEL JM (OR EQUAL), SIZED PER EQUIPMENT CAPACITY.
- 6. BACKFLOW PREVENTION: THIS BUILDING IS PROVIDED WITH A BACKFLOW PREVENTION DEVICE ON THE MAIN WATER SERVICE AND REDUCED PRESSURE BACKFLOW PREVENTION ON THE FOLLOWING PIECES OF EQUIPMENT:
- --



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Jefferson Elementary School Addition and Remodel

DATE: December 9, 2022 LKV PROJECT #: -REVISIONS:

DRAWN BY: CD CHECKED BY: BC

Design Development

DRAWING NO

P-5.0

	KI	TCF	HEN	PL	.UM	BIN	G F	IXTURE SCHEDULE
	FIXTURE DESCRIPTION			CONNEC	TION SIZE			
SYMBOL		WASTE	VENT	TRAP	CW	HW	GAS	MANUFACTURER / MODEL NUMBER / DESCRIPTION / ADDITIONAL COMMENTS
(K-1)	WALK IN FREEZER	SIZE	NSATE DRA AND TERMI TO FLOOR	NATE				PLUMBING CONTRACTOR TO ROUTE CONDENSATE LINE FULL SIZE AND TERMINATE INDIRECTLY. ELECTRICAL TO PROVIDE HEAT TAPE. INSULATE LINE AFTER HEAT TAPE HAS BEEN INSTALLED.
(K-2)	WALK IN COOLER	SIZE	NSATE DRA AND TERMI TO FLOOR	NATE				PLUMBING CONTRACTOR TO ROUTE CONDENSATE LINE FULL SIZE AND TERMINATE INDIRECTLY.
(K-5)	STEAM TABLE	TERMIN	E FULL SIZI NATE INDIR DOR SINK <u>F</u>	ECT TO				PLUMBING CONTRACTOR TO ROUTE DRAIN LINES FULL SIZE AND TERMINATE INDIRECTLY.
K-12	TABLE DOUBLE SINK	2" DRAIN, ROUTE AND TERMINATE INDIRECT TO FLOOR SINK <u>FS-2</u>		1/2	1/2		PROVIDED BY OTHERS, ROUGH-IN AND CONNECTED BY PLUMBING CONTRACTOR. PLUMBING CONTRACTOR TO PROVIDE DRAIN VALVE/GATES WITH HANDLE AT SINK FOR EACH TAILPIECE FROM EACH SEPARATE BASIN, COMBINE SEPARATE LINES TO (1) 2" LINE AND TERMINATE INDIRECTLY AT FLOOR SINK.	
K-13	TABLE TRIPLE SINK	2" DRAIN, ROUTE AND TERMINATE INDIRECT TO FLOOR SINK <u>FS-2</u>					PROVIDED BY OTHERS, ROUGH-IN AND CONNECTED BY PLUMBING CONTRACTOR. PLUMBING CONTRACTOR TO PROVIDE DRAIN VALVE/GATES WITH HANDLE AT SINK FOR EACH TAILPIECE FROM EACH SEPARATE BASIN, COMBINE SEPARATE LINES TO (1) 2" LINE AND TERMINATE INDIRECTLY AT FLOOR SINK.	
K-14	PRE-RINSE UNIT				1/2	1/2	7	PROVIDED BY OTHERS, ROUGH-IN AND CONNECTED BY PLUMBING CONTRACTOR
K-16	STEAM KETTLE WITH DRAIN DRAWER	1 1/4" DRAIN, ROUTE AND TERMINATE INDIRECT TO FLOOR SINK <u>FS-3</u>		1/2	1/2		PROVIDED BY OTHERS, ROUGH-IN AND CONNECTED BY PLUMBING CONTRACTOR	
K-19	DISH TABLE WITH WITH INTEGRAL SINKS	2" DRAIN, ROUTE AND TERMINATE INDIRECT TO FLOOR SINK <u>FS-2</u>		<i></i>			PROVIDED BY OTHERS, ROUGH-IN AND CONNECTED BY PLUMBING CONTRACTOR.	
<b>K</b> -19.)	DISH TABLE WITH INTEGRAL LIQUIDS SINK	1 1/2" DRAIN INDIRECT TO FLOOR SINK FS/2		1/2			INTEGRAL SINK PROVIDED BY OTHERS, ROUGH-IN AND CONNECTED BY PLUMBING CONTRACTOR. COLD WATER CONNECTION SHALL BE CONTROLLED BY FOOT PEDAL SEE FP-1 IN PLUMBING FIXTURE SCHEDULE.	
K-20	DISHWASHER	TERMIN	RAIN, ROU NATE INDIR OOR SINK <u>F</u>	ECT TO		3/4		PROVIDED BY OTHERS, ROUGH-IN AND CONNECTED BY PLUMBING CONTRACTOR. PLUMBING CONTRACTOR SHALL INSTALL DRAIN COOL DOWN KIT, PROVIDE WITH WASHER. ROUTE AND PROVIDE 3/4" HW LINE FROM BOOSTER HEATER, PLUMBING CONTRACTOR TO PROVIDE AND INSTALL <u>SA-1</u> .
(K-21)	BOOSTER HEATER FOR K-20		<b></b>			3/4		PROVIDED BY OTHERS, ROUGH-IN AND CONNECTED BY PLUMBING CONTRACTOR, CONNECT TO K-20
K-25	SINGLE COMBINATION OVEN	TERMIN	E FULL SIZI NATE INDIR DOR SINK <u>F</u>	ECT TO	3/8 & 3/4			PROVIDED BY OTHERS, ROUGH-IN AND CONNECTED BY PLUMBING CONTRACTOR. THIS OVEN HAS TWO CONNECTIONS, (1) FOR STEAM 3/8" AND (1) FOR TEMPERING DRAIN WATER 3/4". INSTALL FILTER PRIOR TO STEAM CONNECTION ONLY. FILTER PROVIDED WITH OVEN. ROUTE DRAIN FULL SIZE THOUGH HALF WALL OVER TO FS-3 AND TERMINATE INDIRECTLY.
(K-26)	ICE MACHINE	TERMIN	E FULL SIZI NATE INDIR DOR SINK <u>F</u>	ECT TO	1/2			PROVIDED BY OTHERS, ROUGH-IN AND CONNECTED BY PLUMBING CONTRACTOR. PROVIDE SHUT OFF VALVE AT WALL BEHIND ICE MACHINE. PROVIDE FLEXIBLE CONNECTION FROM VALVE TO UNIT ALLOWING UNIT TO BE PULLED AWAY FROM WALL A MINIMUM OF 6 FEET. WATER LINE FROM RPBP-1

NOTES

<sup>2</sup> ALL EXPOSED HW PIPING, CW PIPING, AND DRAIN LINES BENEATH ALL SINKS MUST BE INSULATED TO PREVENT INJURY. REFER TO ARCHITECTURAL PLANS. INSULATE WITH MOLDED CLOSED CELL VINYL INSULATION -

	GAS SIZIN	IG CHART	
SYMBOL	INPUT (MBH)	RUNOUT SIZE (2PSI) (INCHES)	EQUIPMENT CONNECTION SIZES (7" WC) (INCHES)
RTU-P1	108	1/2	1/2
RTU-F2	108	1/2	1/2
MAU-F1	512	3/4	1 1/4
MAU-F2	358	3/4	1
<u>WH-1</u>	199	3/4	1
<u>WH-2</u>	199	3/4	1
<u>K-1.1</u>	35	SEE PLANS	1/2
<u>K-1.1</u>	35	SEE PLANS	1/2
<u>K-48</u>	160	SEE PLANS	1
<u>K-48</u>	160	SEE PLANS	1
<u>K-48.1</u>	240	SEE PLANS	1
<u>K-48.1</u>	240	SEE PLANS	1
<u>K-61</u>	80	SEE PLANS	3/4
<u>K-62</u>	110	SEE PLANS	3/4
<u>K-62</u>	110	SEE PLANS	3/4
<u>K-62</u>	110	SEE PLANS	3/4
<u>K-111</u>	90	SEE PLANS	3/4
<u>K-115</u>	50	SEE PLANS	1/2
<u>K-119</u>	211	SEE PLANS	1
<u>K-122</u>	60	SEE PLANS	1/2
<u>K-122</u>	60	SEE PLANS	1/2
<u>K-124</u>	144	SEE PLANS	1
TOTAL	3379.0	PRESSUI	ENGTH = 125 FT RE = 2 PSI ZE =1 1/2"

NOTE: GAS SIZES TO EQUIPMENT ARE AS NOTED IN SCHEDULE ABOVE. ROUTE NOTED (2PSI) GAS LINE TO GAS EQUIPMENT. PROVIDE GAS COCK AND PRESSURE REGULATOR (2 PSI-7" WC) SIZED FOR GAS LOAD AT EACH PIECE OF EQUIPMENT. VENT TO ATMOSPHERE PER MANUFACTURERS RECOMMENDATIONS. ROUTE NOTED (7" WC) GAS LINE TO GAS FIRED EQUIPMENT WITH GAS COCK AND FLEX CONNECTOR AT UNIT. SEE GAS CONNECTION DETAILS.

LKV ARCHITECTS

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DRAWING NO.

P-5.1

<sup>1.</sup> ALL ADA COMPLIANT FIXTURES MUST COMPLY WITH ICC/ANSI A117.1. SEE ARCHITECTURAL PLANS FOR HANDICAPPED FIXTURE DESIGNATIONS, LOCATIONS, CLEARANCES, AND MOUNTING HEIGHTS.